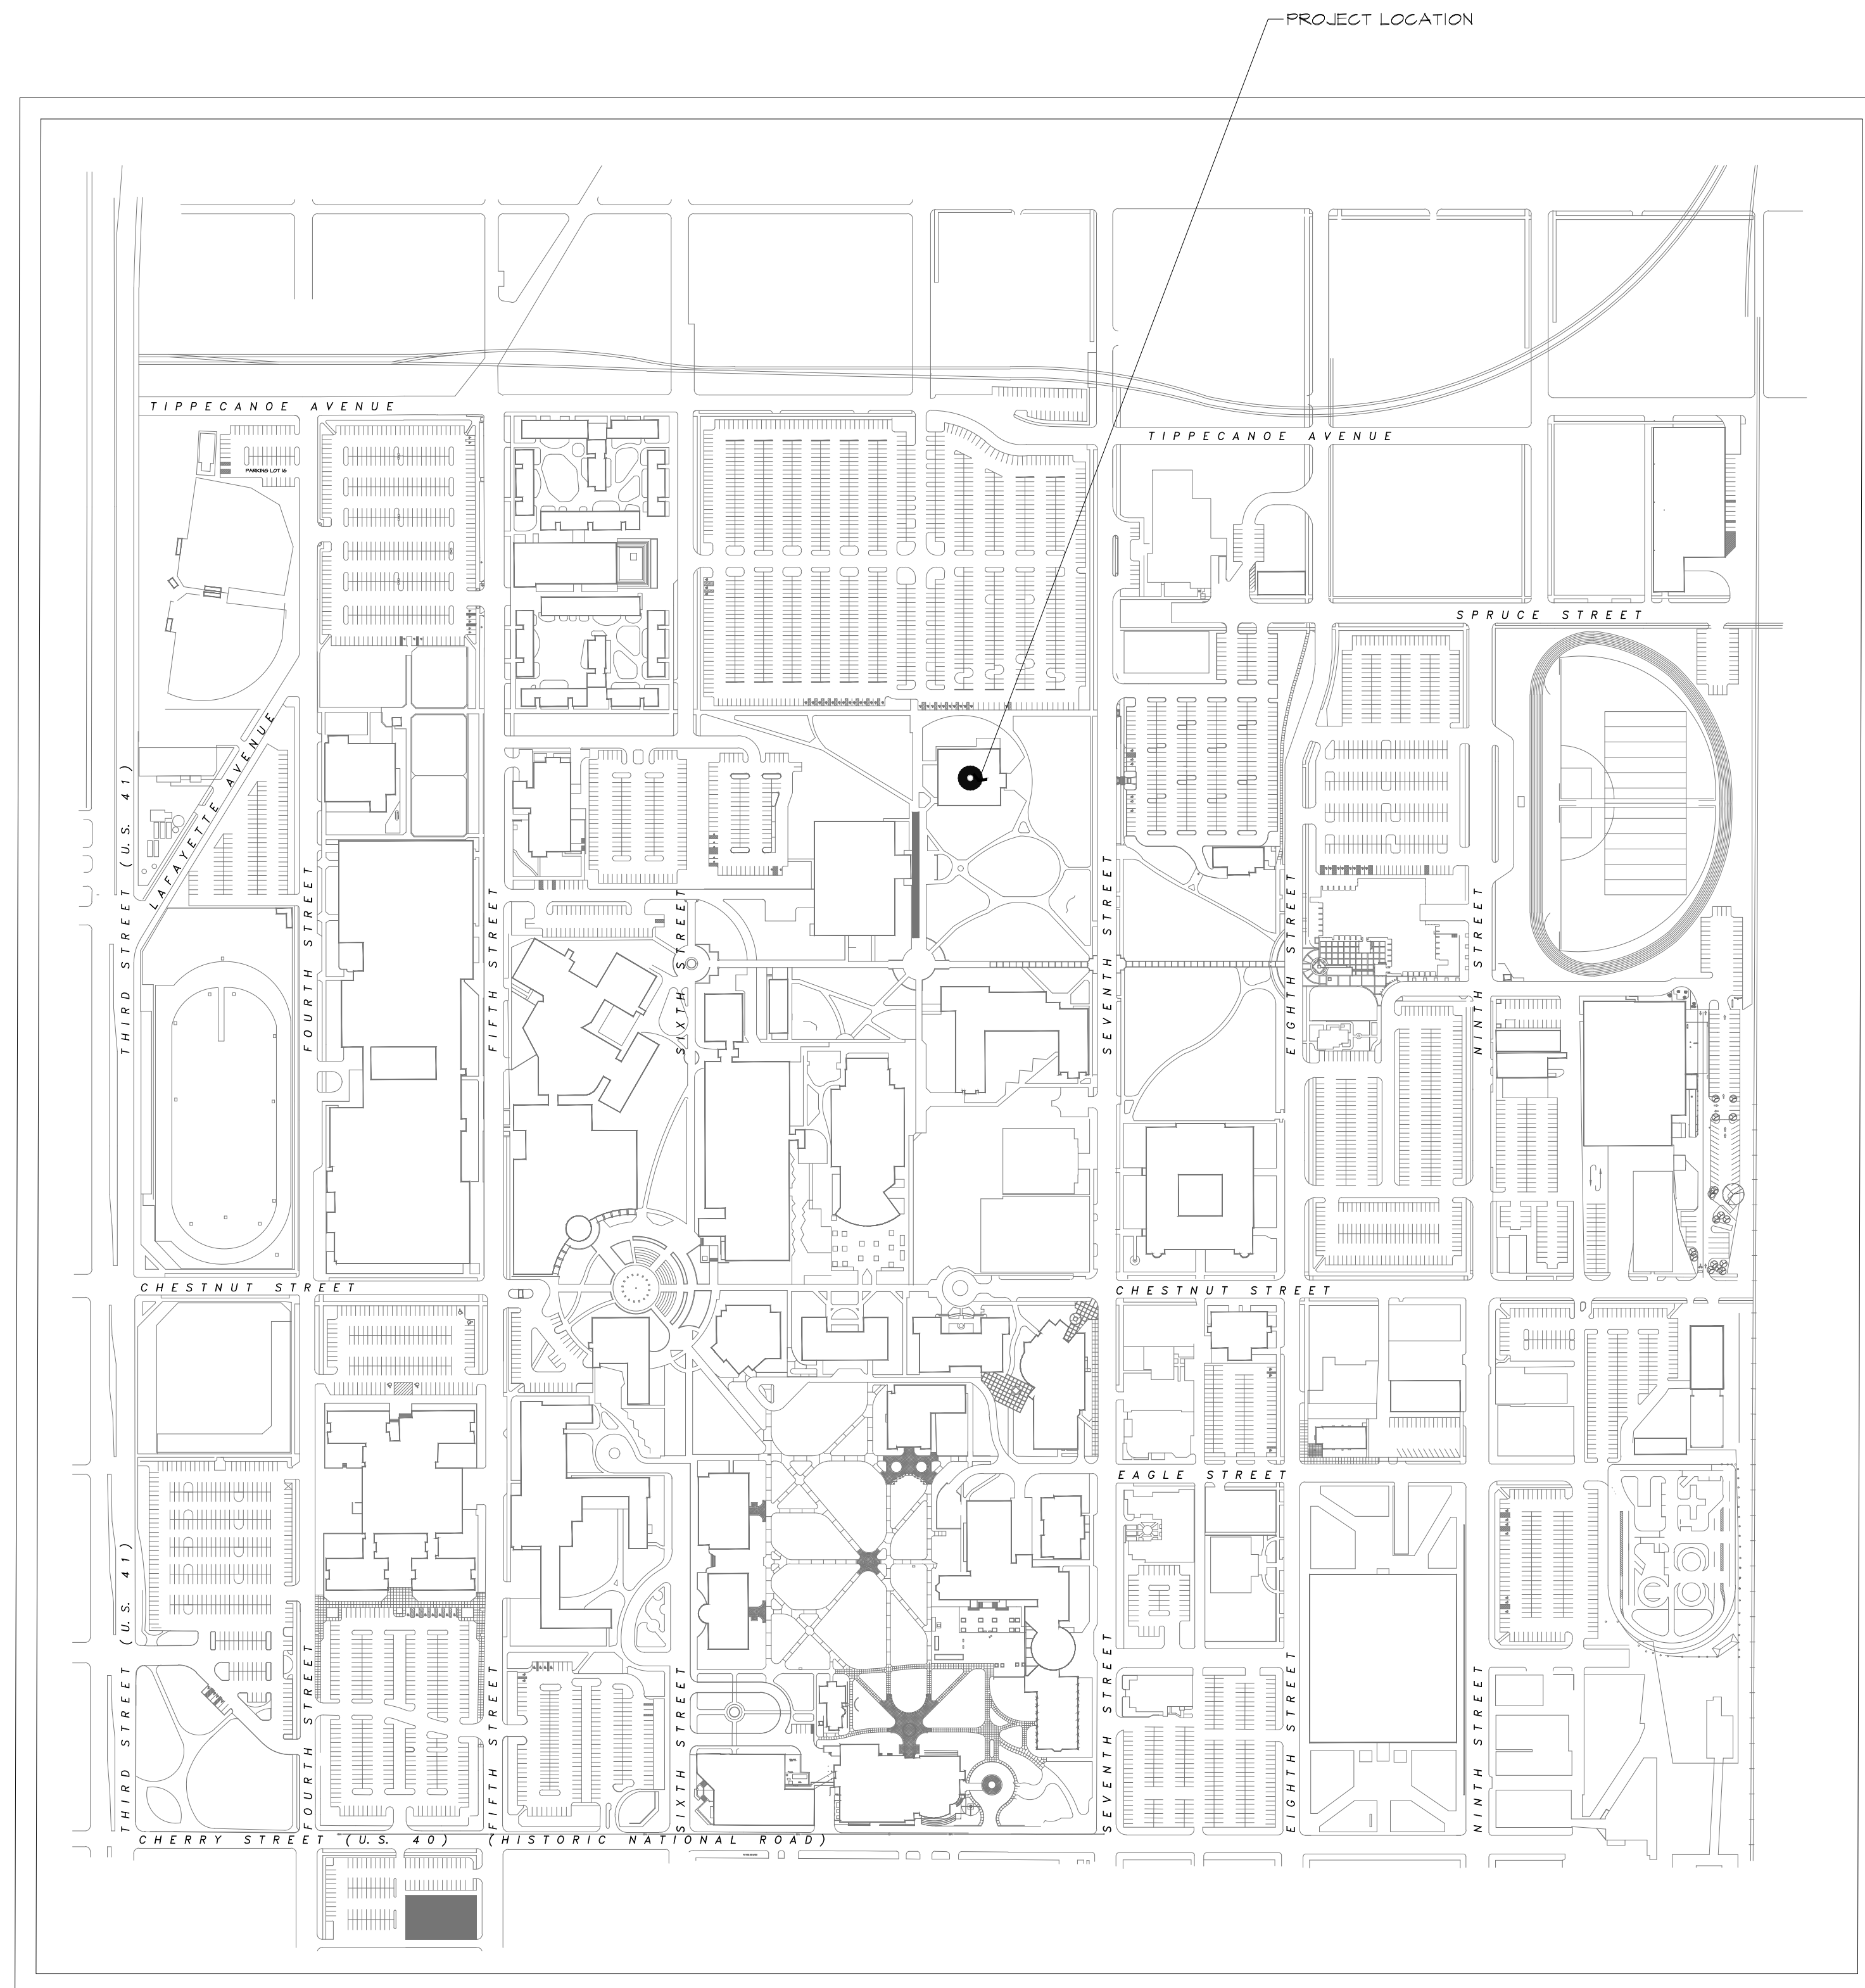


# THEATER BUILDING DRESSING ROOM / REST ROOM REMODEL



PROJECT LOCATION MAP

## DRAWING INDEX

GENERAL  
PM001 SYMBOLS

DEMOLITION  
D101 DEMOLITION PLAN

ARCHITECTURAL  
A101 FLOOR PLAN  
A200 ELEVATIONS

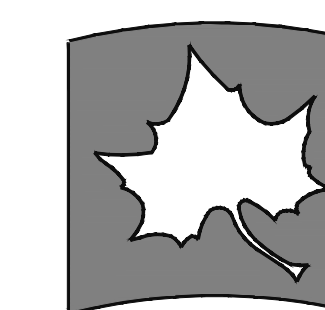
ELECTRICAL  
E001 ELECTRICAL SYMBOLS  
ED201 ELECTRICAL DEMOLITION  
E201 ELECTRICAL PLAN  
E211 POWER PLAN

MECHANICAL  
MD201 MECHANICAL DEMOLITION  
M201 MECHANICAL PLAN  
M601 MECHANICAL DETAILS

PLUMBING  
PD201 PLUMBING DEMOLITION  
P201 PLUMBING PLAN  
P601 PLUMBING DETAILS


FIRE PROTECTION  
FP2011 FIRE PROTECTION PLAN

DATE: 1/22/2025 PROJ. NO.: B0028552



INDIANA STATE UNIVERSITY

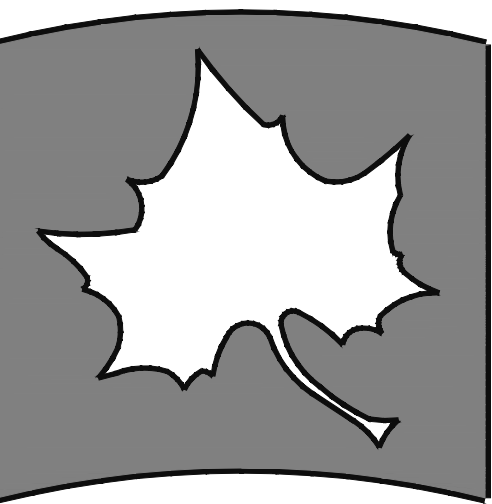Facilities Management  
951 Sycamore Street  
Terre Haute, IN 47809  
phone: (812) 237-8100 fax: (812) 237-7630




INDIANA STATE UNIVERSITY

Facilities Management Department  
951 Sycamore Street  
Terre Haute, Indiana 47809  
Phone: (812) 237-6100 Fax: (812) 237-1650

THEATER BUILDING

DRESSING ROOM / REST ROOM REMODEL

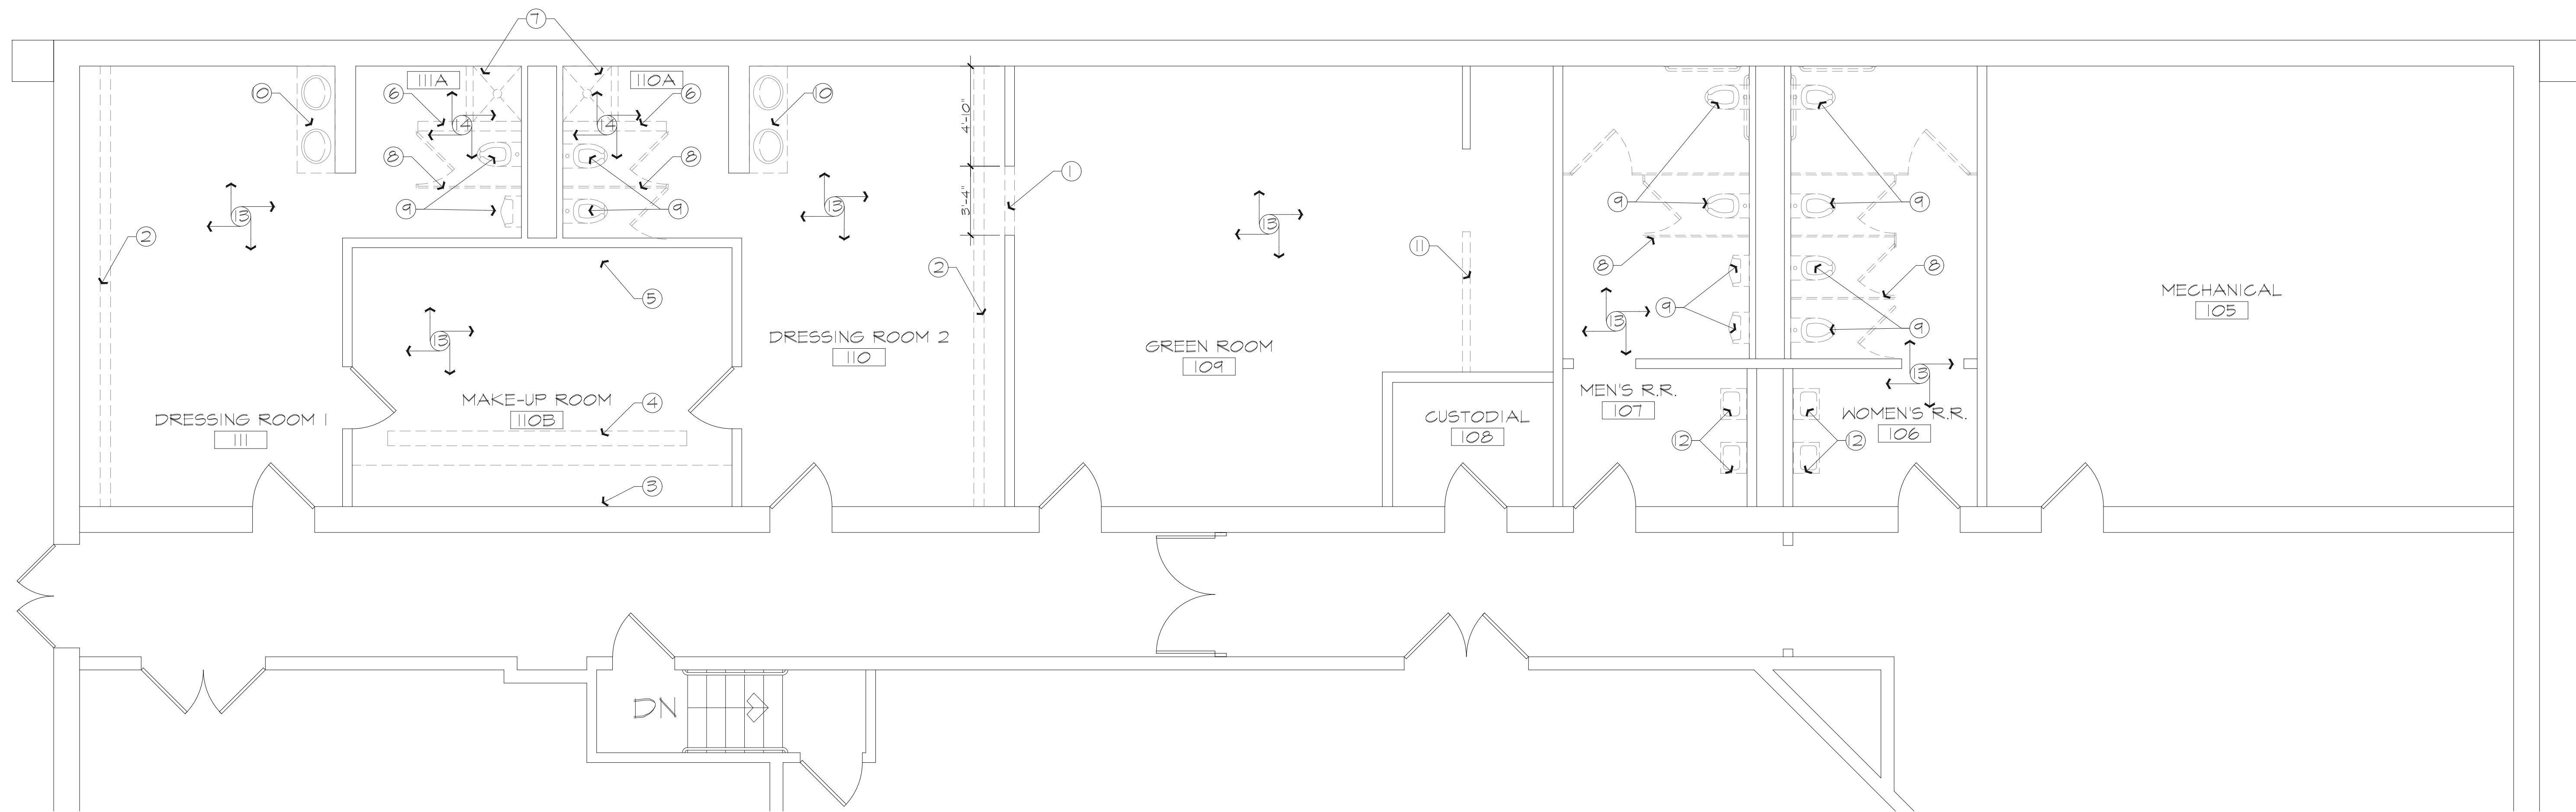DEMOLITION PLAN



DEMOLITION PLAN   
SCALE: 1/4" = 1'-0"


**DEMOLITION NOTES:**

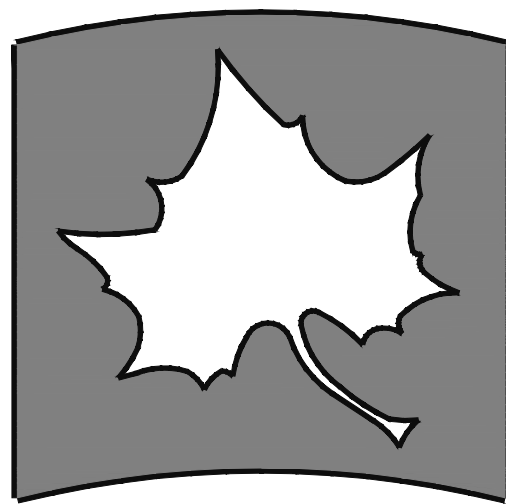- ① DEMO PARTIAL WALL OPENING FOR INSTALLATION OF A 3'-0" X 6'-8" DOOR AND METAL FRAME.
- ② REMOVE EXISTING SHELF AND ROD COMPLETE.
- ③ REMOVE EXISTING COUNTER, MIRRORS AND LIGHTING COMPLETE. REMOVE EXISTING DRYWALL, FRAMING TO REMAIN.
- ④ REMOVE EXISTING BENCH SEATING COMPLETE.
- ⑤ REMOVE EXISTING PLUMBING COMPLETE.
- ⑥ REMOVE EXISTING BLOCK WALL COMPLETE.
- ⑦ REMOVE EXISTING SHOWER COMPLETE.
- ⑧ REMOVE EXISTING STALL PARTITIONS COMPLETE.
- ⑨ REMOVE EXISTING PLUMBING FIXTURES. SALVAGE FOR RE-INSTALLATION.
- ⑩ REMOVE EXISTING SINKS AND COUNTER COMPLETE.

- ⑪ REMOVE EXISTING WALL COMPLETE.
- ⑫ REMOVE EXISTING WALL HUNG SINKS COMPLETE.
- ⑬ REMOVE EXISTING FLOORING AND BASE COMPLETE. REMOVE EXISTING CEILING, GRID AND LIGHTING COMPLETE. REMOVE ALL WALL ACCESSORIES AND OTHER ITEMS COMPLETE.
- ⑭ REMOVE EXISTING DRYWALL CEILING COMPLETE.

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| PROPERTY NO.: |              |
| REVISIONS     |              |
| 1             |              |
| 2             |              |
| DATE:         | 1/22/2025    |
| SCALE:        | 1/4" = 1'-0" |
| DRAWN BY:     | S. STILLMAN  |
| CHECKED BY:   | B. DUNCAN    |
| APPROVED BY:  |              |
| PROJECT NO.:  |              |

SHEET NO.  
**D101**  
OF SHEETS




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 Facilities Management Department  
 951 Sycamore Street  
 Terre Haute, Indiana 47809  
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THEATER BUILDING  
 DRESSING ROOM / REST ROOM REMODEL  
 FIRST FLOOR PLAN

|               |              |
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| FILENAME:     |              |
| PROPERTY NO.: |              |
| REVISIONS     |              |
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| DATE:         | 1/22/2025    |
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| CHECKED BY:   | B. DUNCAN    |
| APPROVED BY:  |              |
| PROJECT NO.:  |              |

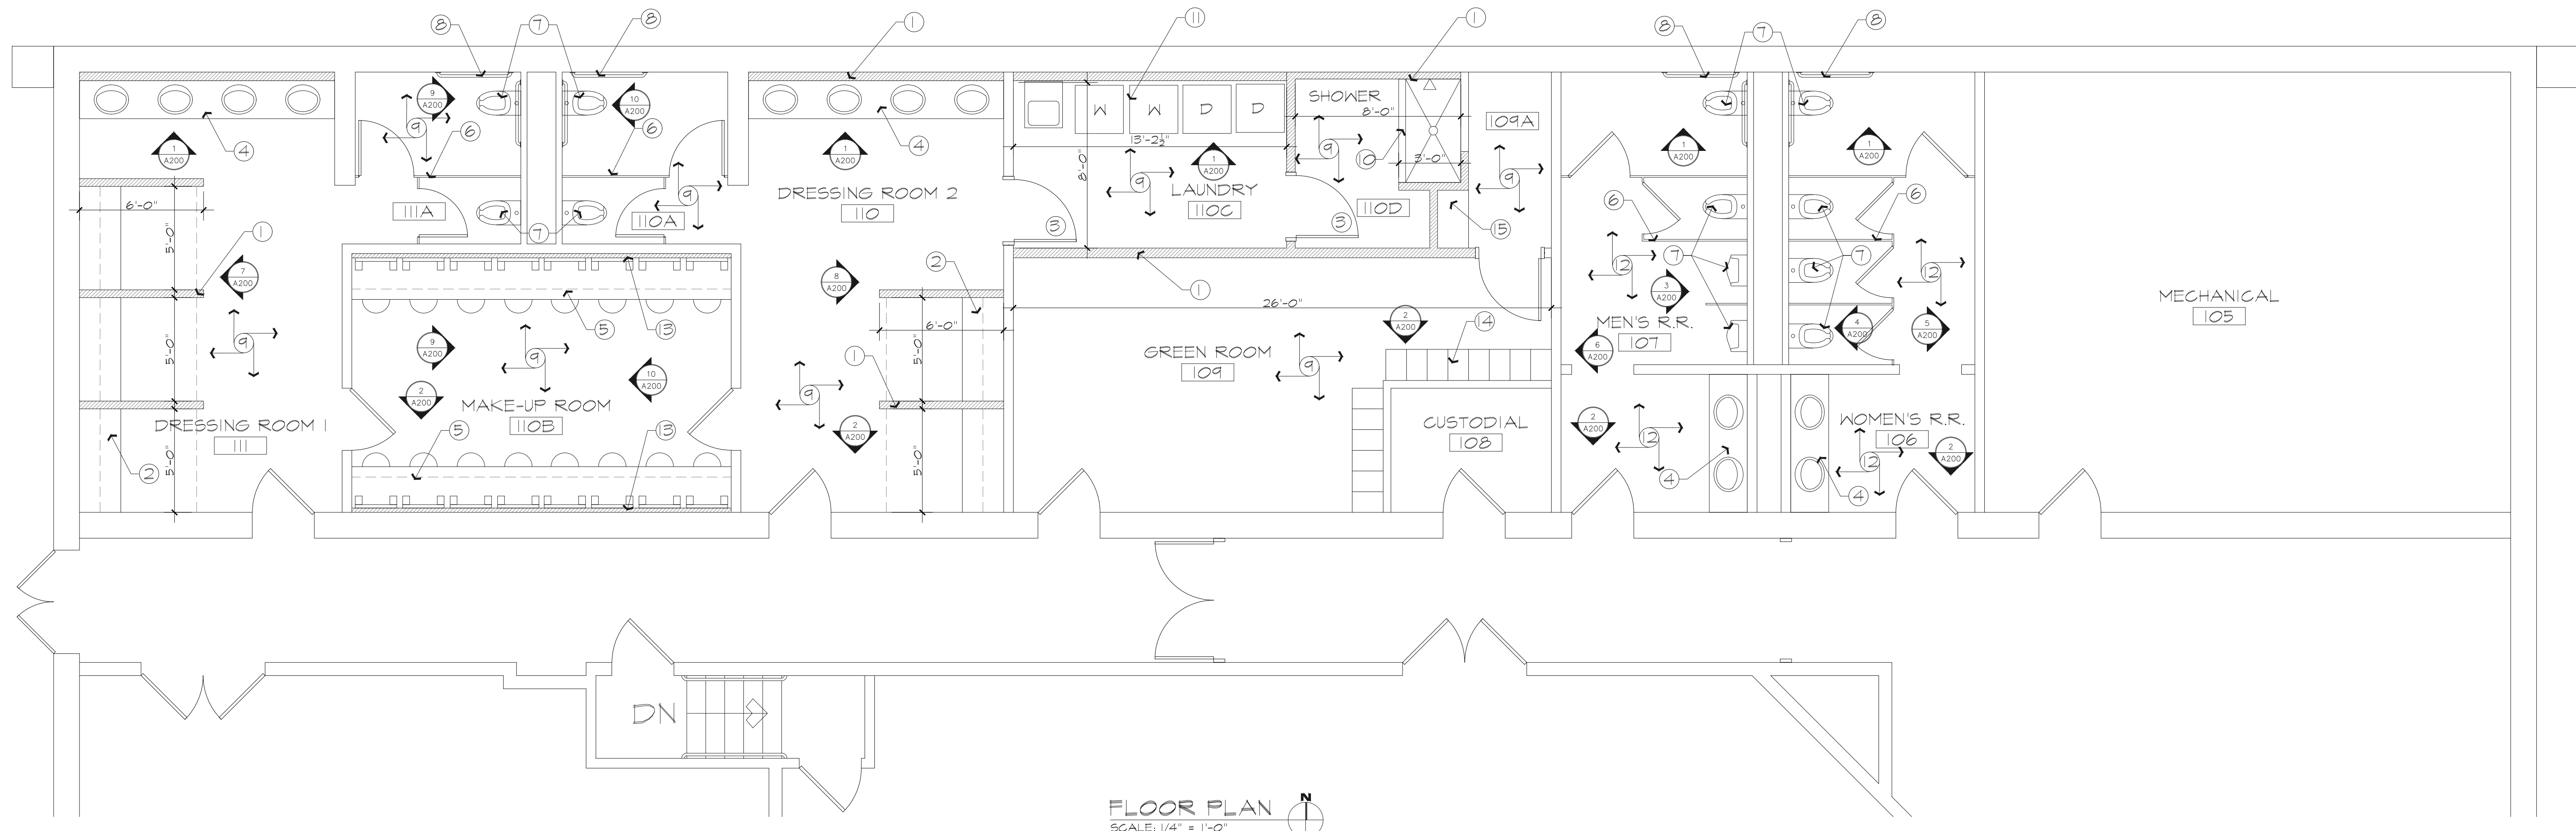
SHEET NO.  
 A101  
 OF SHEETS



FLOOR PLAN  
 SCALE: 1/4" = 1'-0"

**PLAN NOTES:**

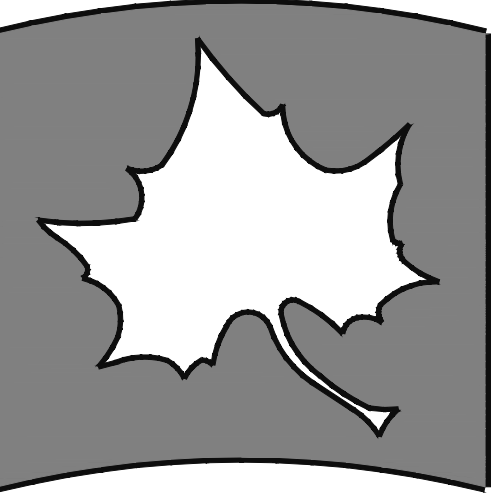- ① CONSTRUCT A NEW 3 5/8" METAL STUD WALL WITH 5/8" DRYWALL. PRIME AND PAINT WALLS TWO FINISH COATS IN COLOR SELECTED BY OWNER. INSTALL VINYL BASE ON NEW WALLS TO MATCH WITH EXISTING. INSTALL SOUND BATT INSULATION.
- ② INSTALL A NEW 24" DEEP SHELF AND METAL COAT ROD.
- ③ INSTALL A NEW 3' X 7' WOOD DOOR IN METAL FRAME. DOOR SHALL MATCH WITH EXISTING FINISH IN AREA.
- ④ INSTALL NEW SOLID SURFACE COUNTER TOP WITH INTEGRAL WHITE BOWLS. SOLID SURFACE AS "CORIAN" IN COLOR STONIQUE. INSTALL METAL SUPPORT BRACKETS AS REQUIRED.
- ⑤ INSTALL A 24" DEEP SOLID SURFACE COUNTER TOP; MIRRORS AND LIGHTING. SOLID SURFACE AS "CORIAN" IN COLOR COPPER MIST. INSTALL AN UPPER WHITE LAMINATE SHELF AND SUPPORT BRACKETS. SEE DETAILS SHEET A200 SEATING BY OTHERS.
- ⑥ INSTALL METAL STALL PARTITIONS AND DOORS. COLOR TO BE SELECTED FROM STANDARD COLOR CHART.
- ⑦ RE-INSTALL WALL HUNG TOILETS AND URINALS.
- ⑧ INSTALL GRAB BARS TO MEET ADA COMPLIANCE.
- ⑨ INSTALL NEW 2' X 2' CEILING GRID AND TILE. CEILING TILE SHALL BE USG CIRRUS RECESSED TILE. INSTALL NEW 18" X 18" LVT FLOORING AS "MANNINGTON" DRY STONE CINDER #65554433 OVER EXISTING CONCRETE FLOOR. INSTALL NEW 4" VINYL BASE IN COLOR TO BE SELECTED BY OWNER. PAINT ALL WALLS TWO FINISH COATS IN COLOR SELECTED BY OWNER.
- ⑩ INSTALL A 60" WIDE ONE PIECE SHOWER UNIT WITH AN ADA COMPLIANT FOLDING SEAT AND GRAB BARS. SHOWER UNIT AS "AQUATIC" MODEL #727149392017 OR APPROVED EQUAL
- ⑪ INSTALL ALL REQUIRED PLUMBING AND ELECTRICAL FOR WASHERS AND DRYERS. WASHERS AND DRYERS ARE SUPPLIED BY OWNER.
- ⑫ INSTALL NEW 2' X 2' CEILING GRID AND TILE. CEILING TILE SHALL BE USG CIRRUS RECESSED TILE. INSTALL NEW 18" X 18" LVT FLOORING AS "MANNINGTON" DRY STONE CINDER #65554433 OVER EXISTING CONCRETE FLOOR. INSTALL NEW 4" VINYL BASE IN COLOR TO BE SELECTED BY OWNER. INSTALL "DAL TILE" CALGARY PORCELAIN WALL TILES IN COLOR "FOG #CG42" SIZE 12" X 24" IN MATTE FINISH. GROUT TO BE SELECTED FROM STANDARD COLOR CHART.
- ⑬ INSTALL 2" METAL HAT CHANNEL AND 5/8" DRYWALL OVER EXISTING MASONRY WALL.
- ⑭ PURCHASE AND INSTALL 14 NEW 12" WIDE METAL LOCKERS TO EXISTING WALL. LOCKERS SHALL BE TWO TIER; 12" WIDE; 18" DEEP; (2) 36" HIGH. COLOR TO BE SELECTED BY OWNER FROM STANDARD COLOR CHART. LOCKING WILL BE BY PADLOCK AND PROVIDED BY USER. LOCKERS PURCHASE AND INSTALLATION WILL BE BID AS ALTERNATE #1.
- ⑮ INSTALL (4) 16" DEEP WHITE LAMINATE SHELVES ON ADJUSTABLE TRACK AND BRACKETS.

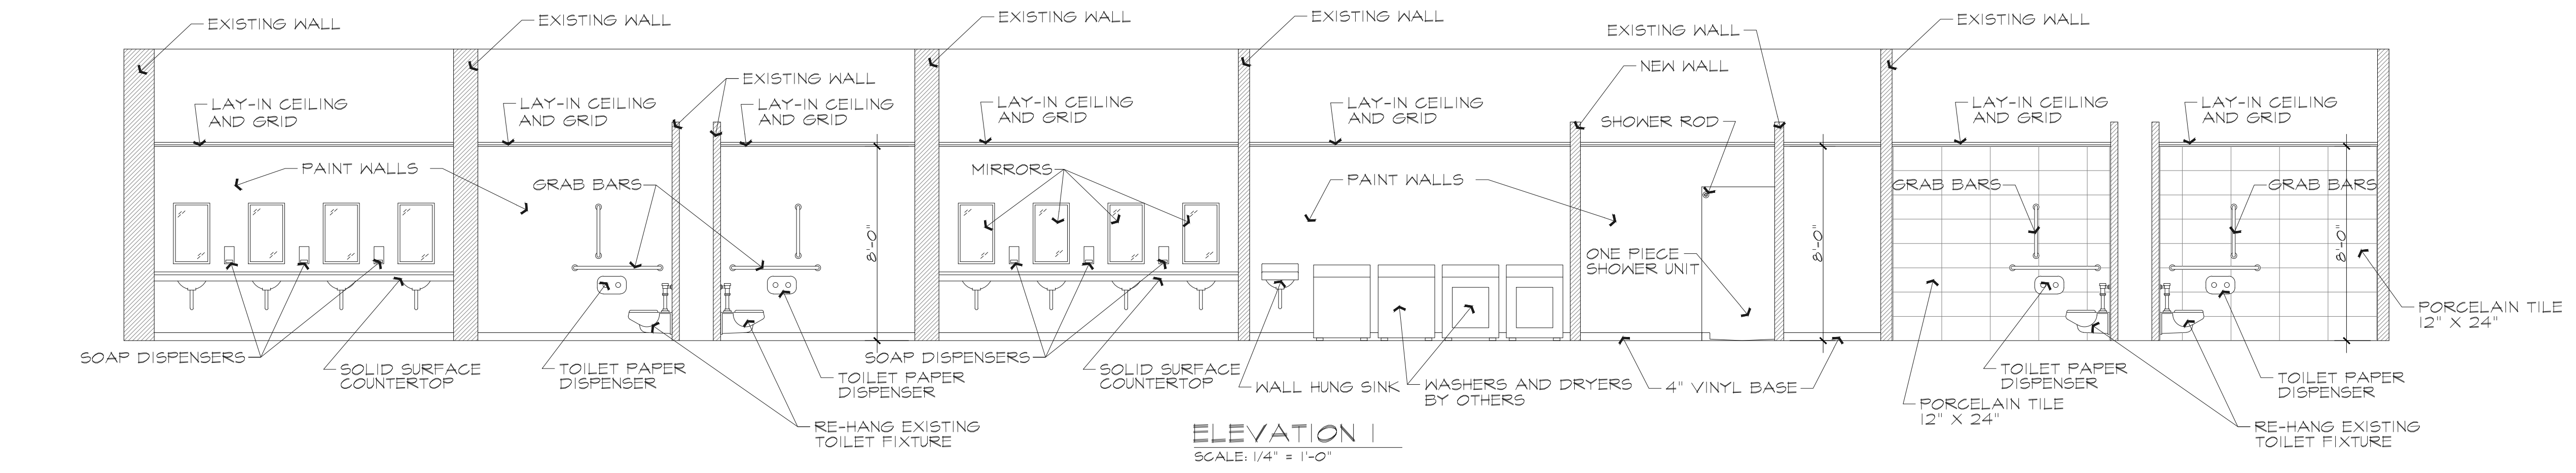


**INDIANA STATE UNIVERSITY**  
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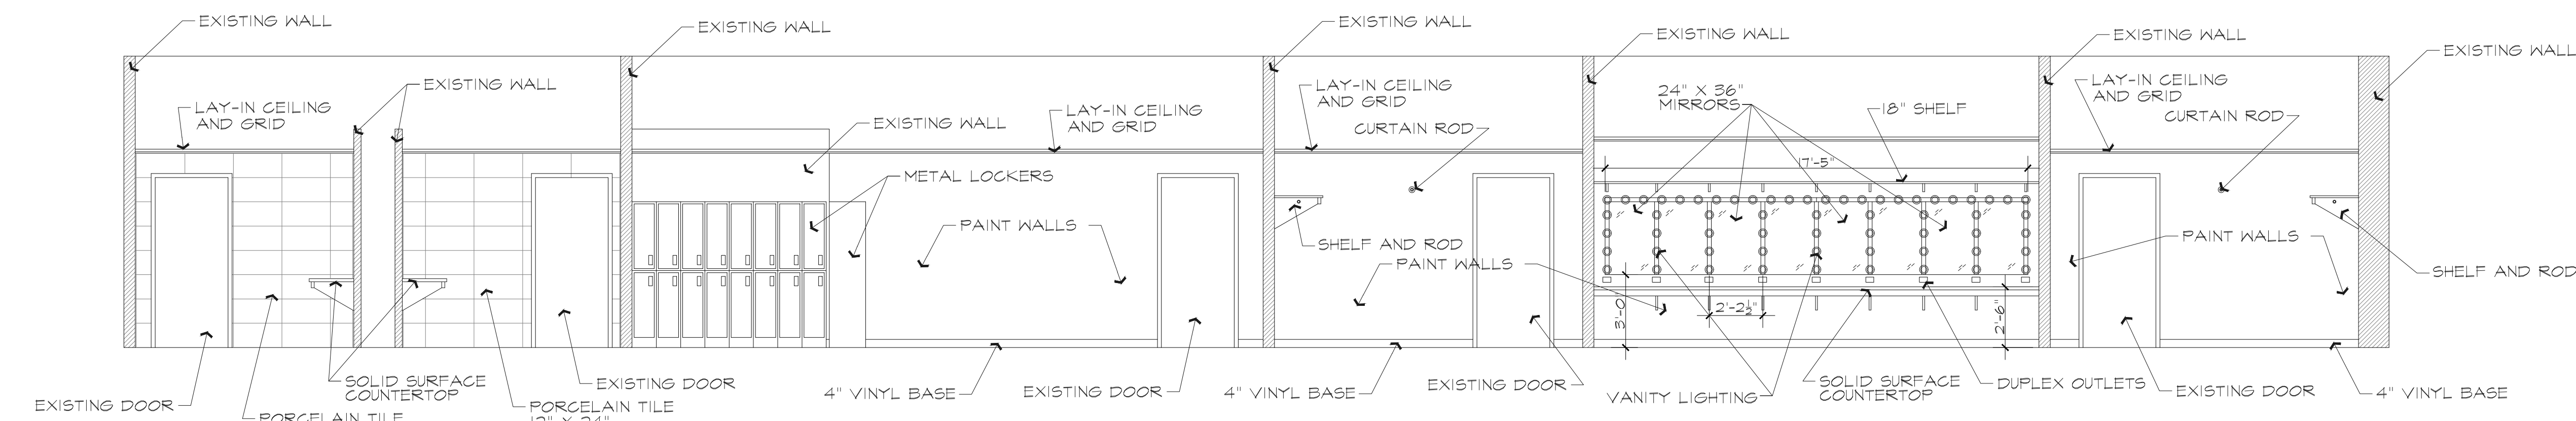
THEATER BUILDING  
 DRESSING ROOM / REST ROOM REMODEL  
 ELEVATIONS

| FILE NAME    | PROPERTY NO. | REVISIONS |
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|              |              | 2         |
| DATE:        | 1/22/2025    |           |
| SCALE:       | 1/4" = 1'-0" |           |
| DRAWN BY:    | S. STILLMAN  |           |
| CHECKED BY:  | B. DUNCAN    |           |
| APPROVED BY: |              |           |
| PROJECT NO.: |              |           |

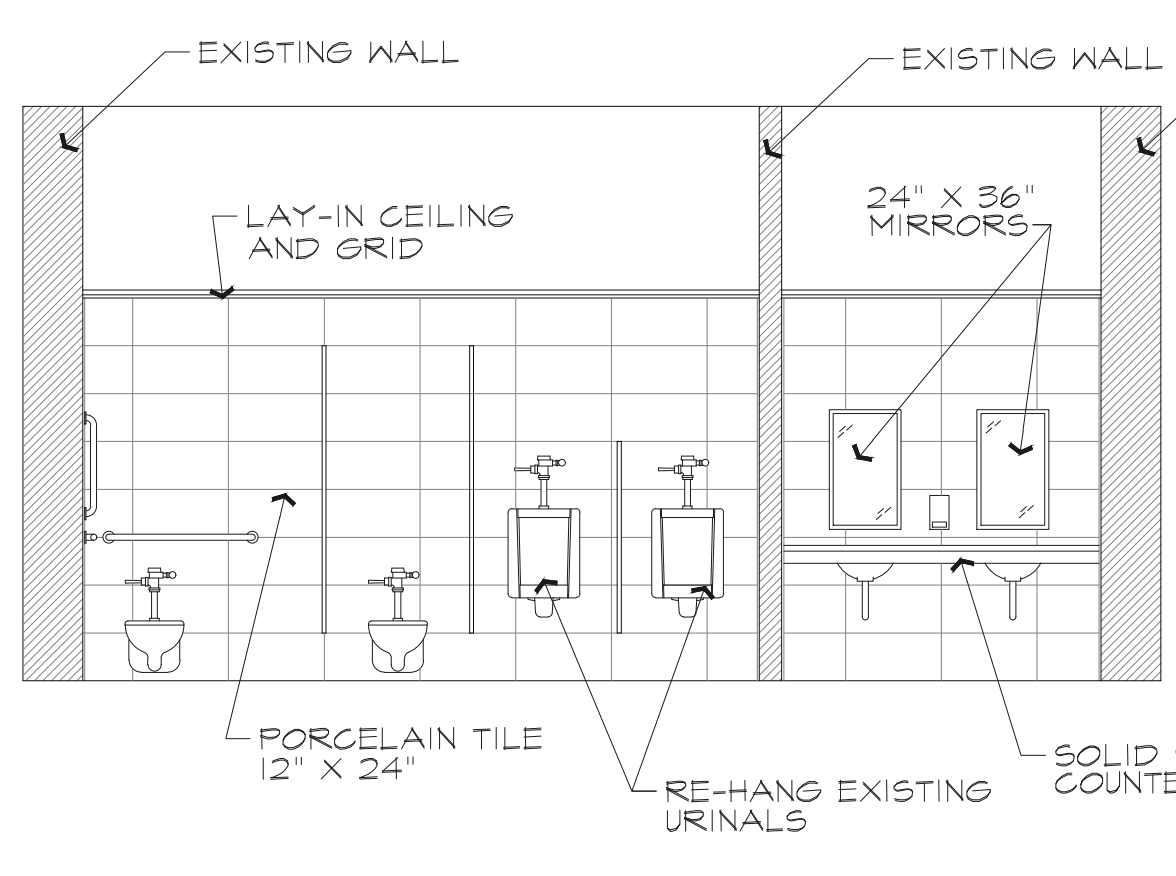
SHEET NO.  
**A200**  
 OF SHEETS



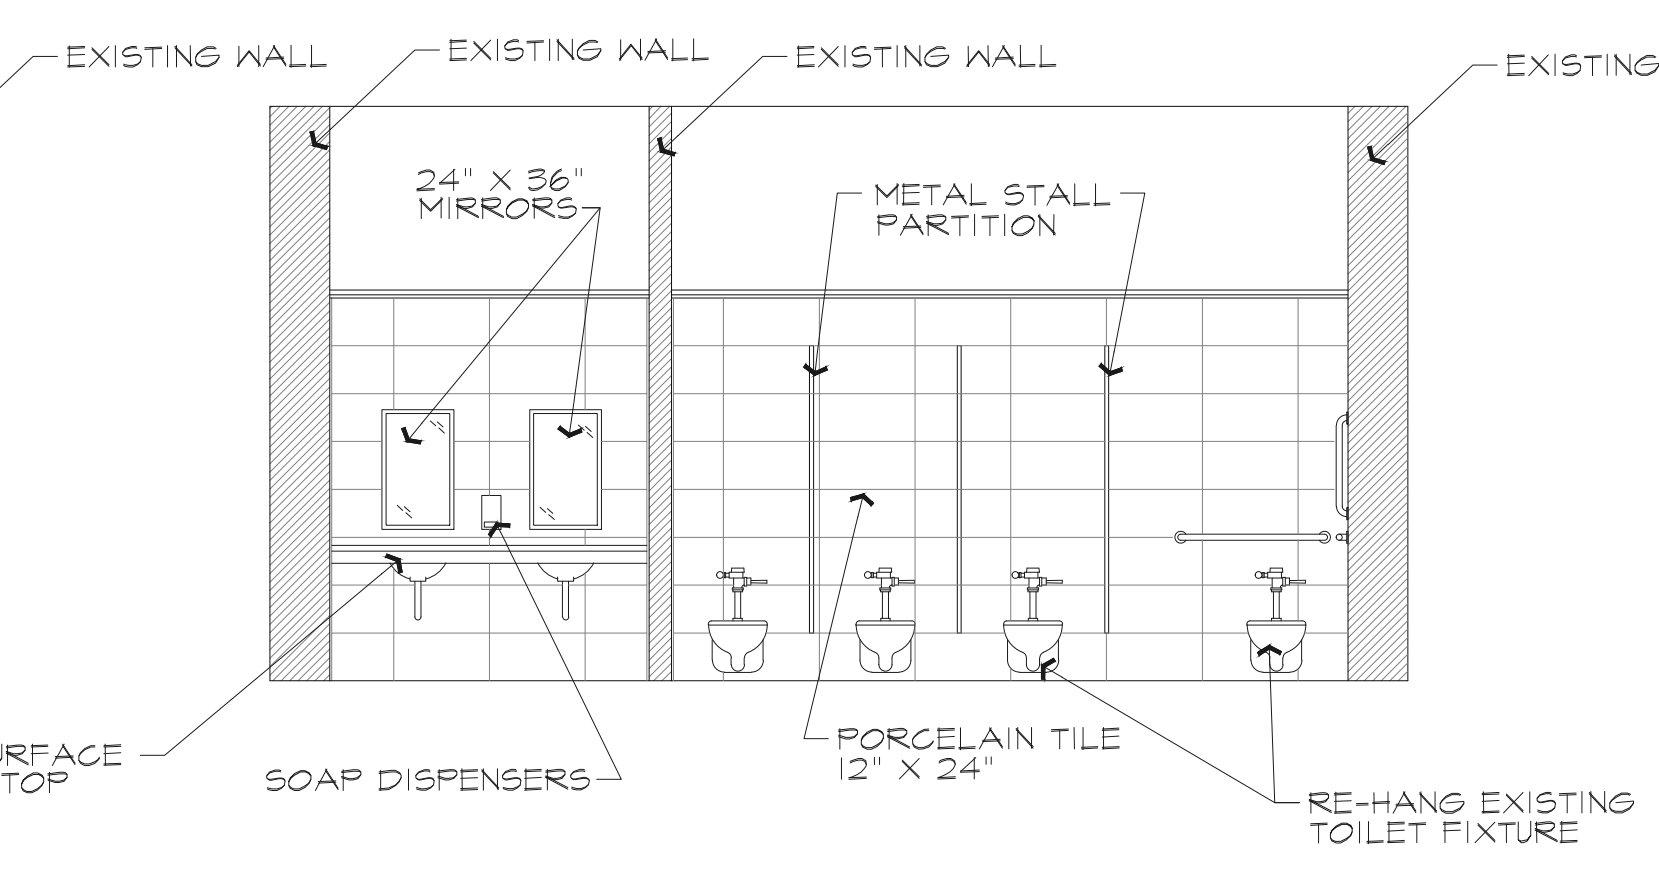
**ELEVATION 1**  
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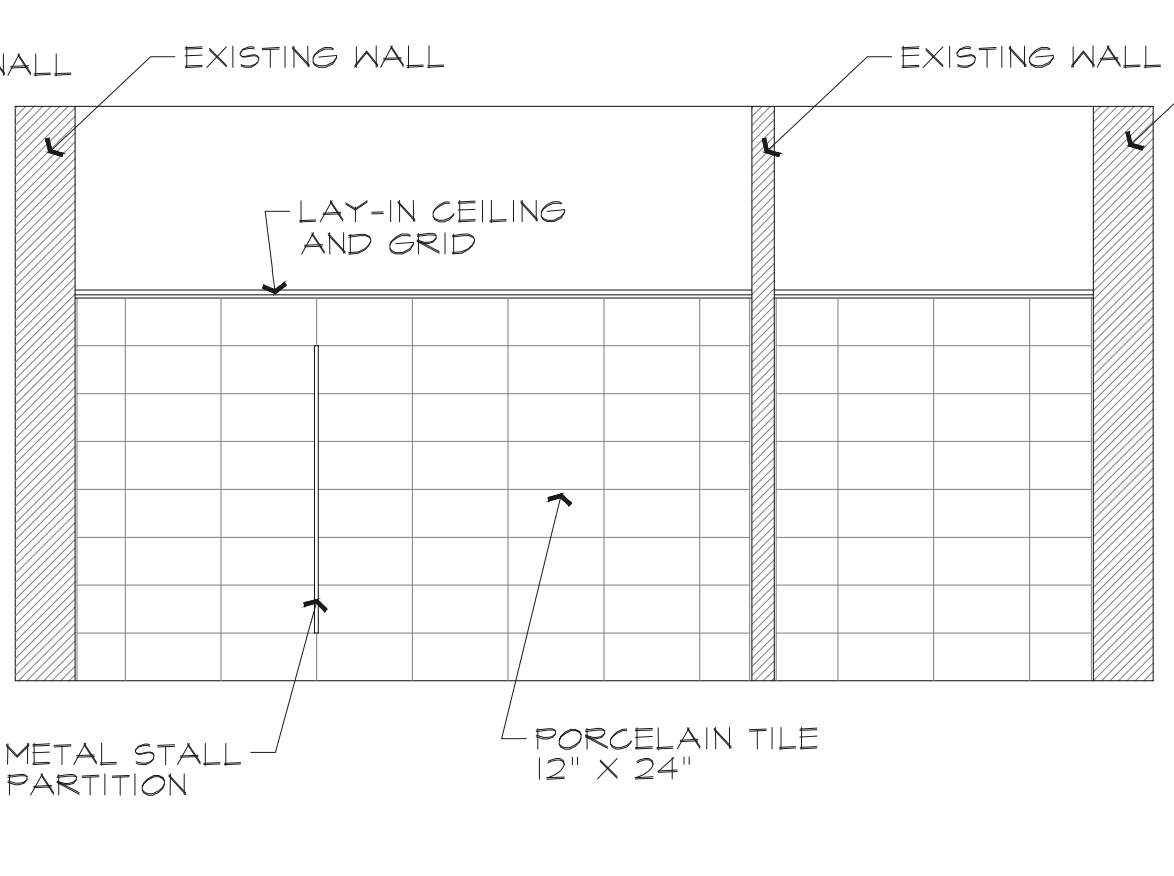
**ELEVATION 2**  
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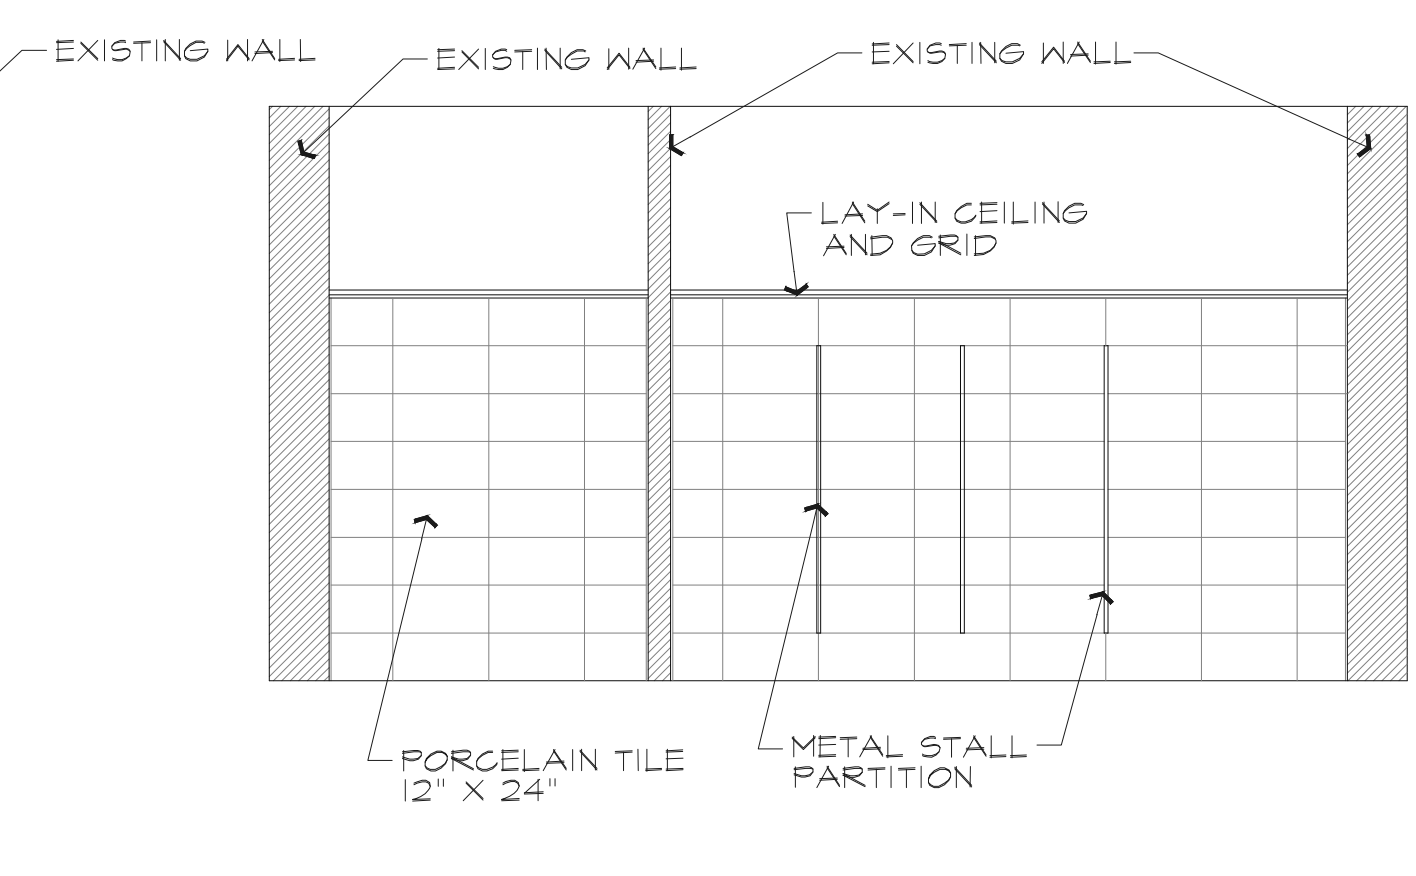
**ELEVATION 3**  
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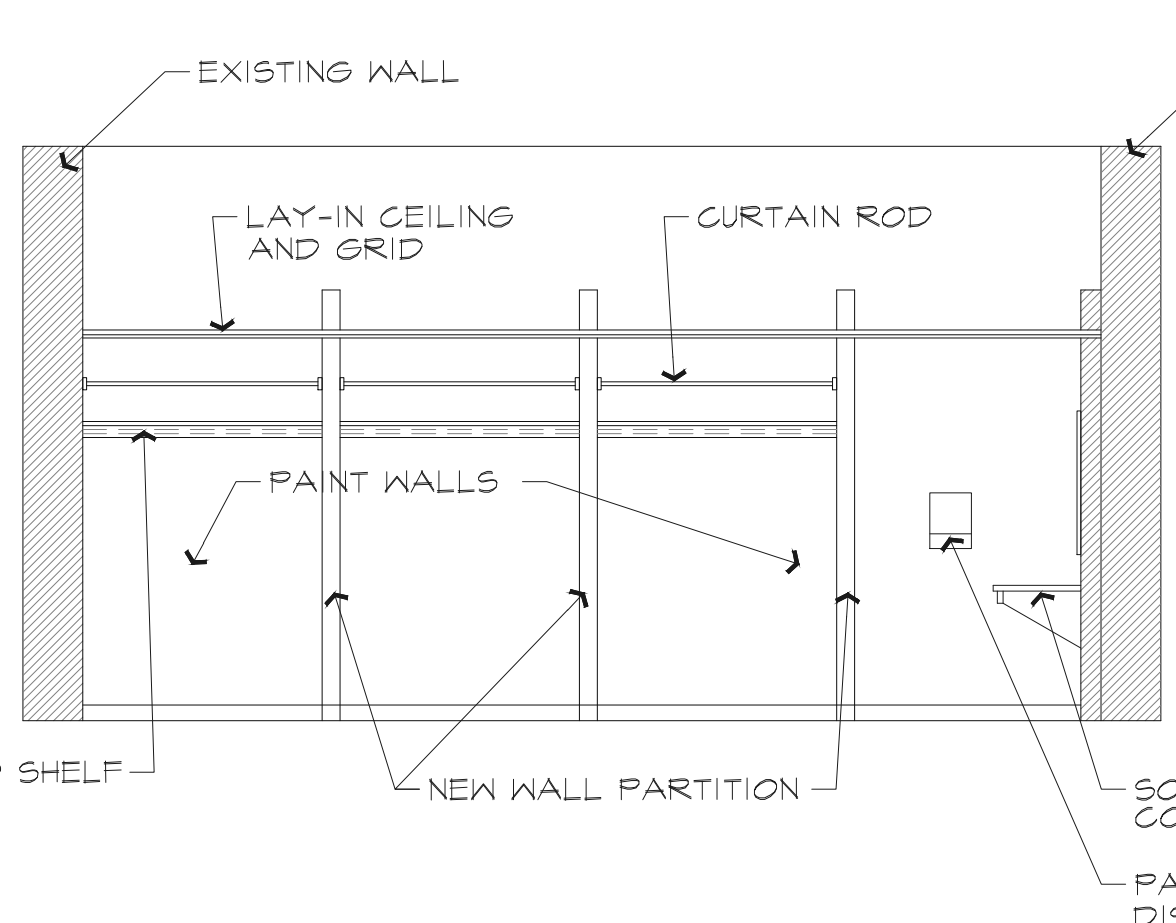
**ELEVATION 4**  
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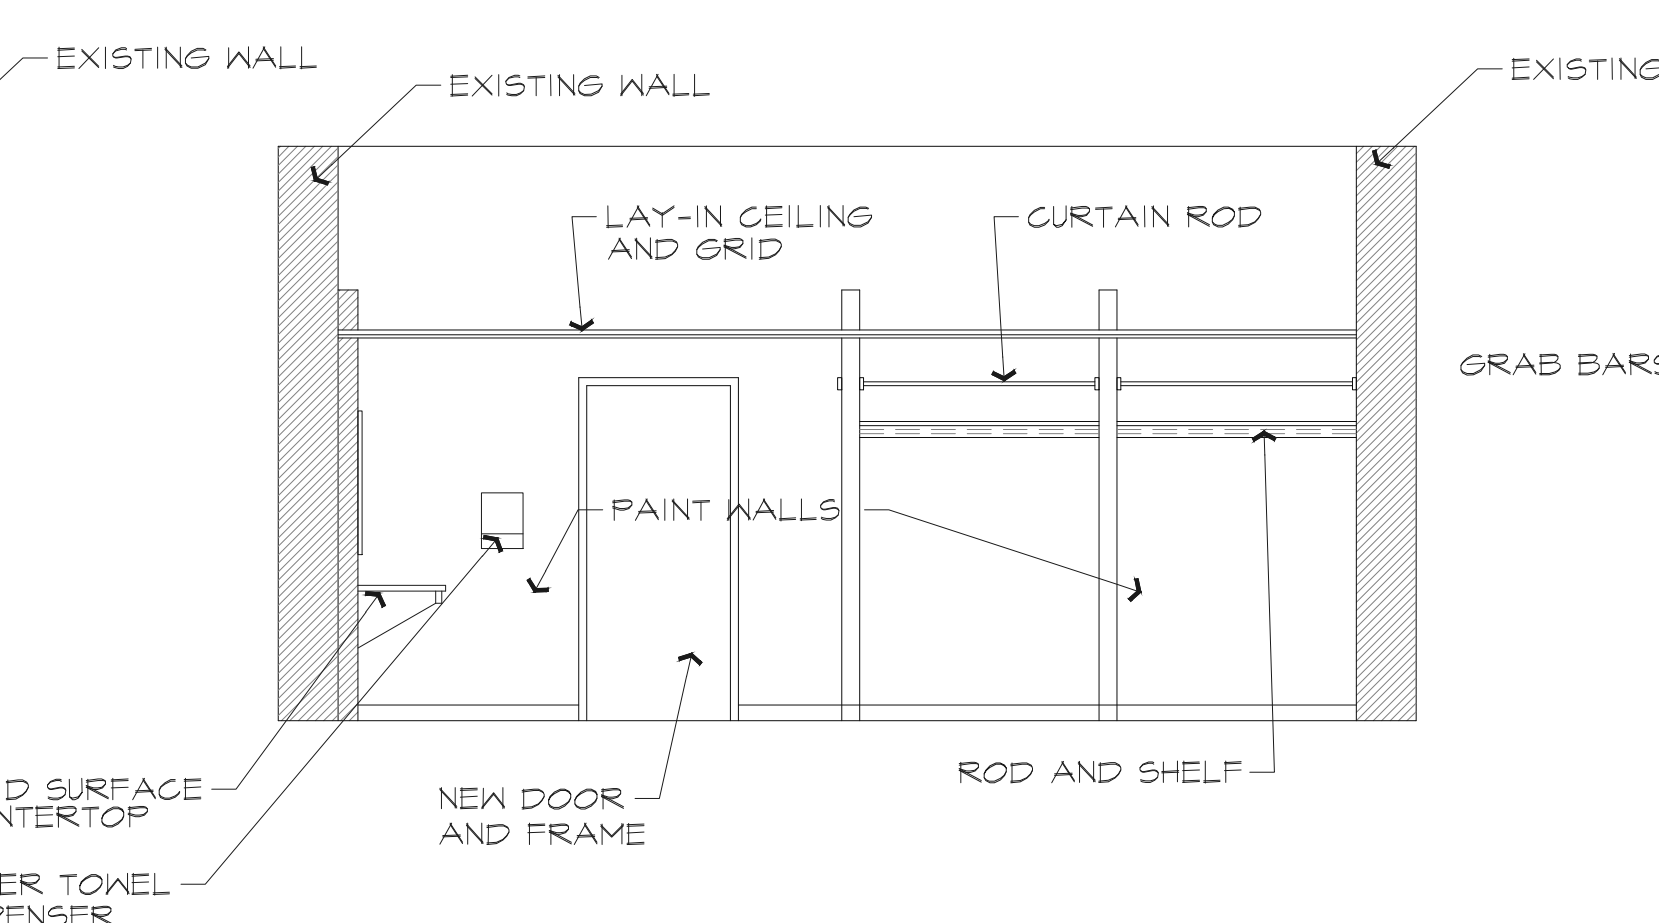
**ELEVATION 5**  
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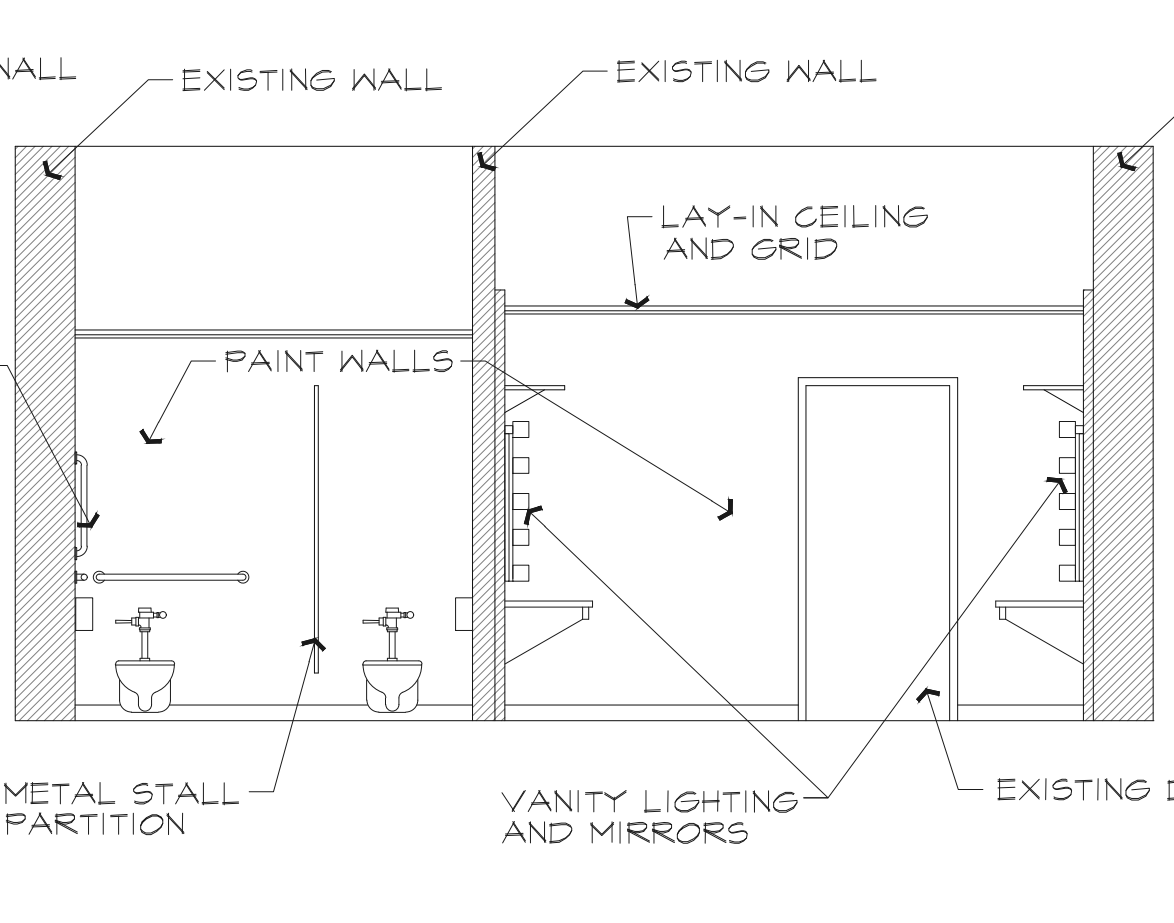
**ELEVATION 6**  
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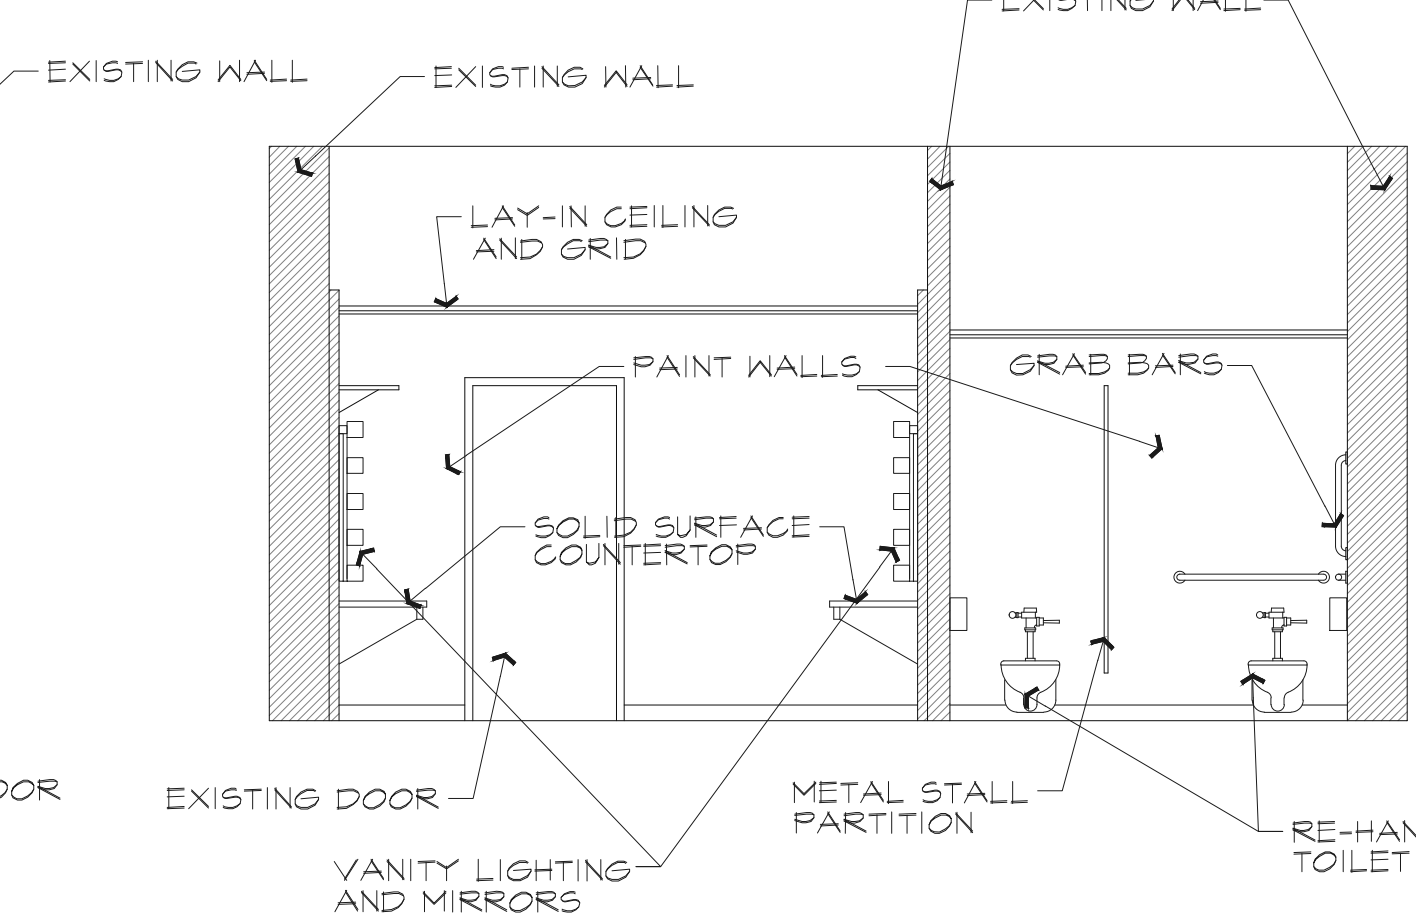
**ELEVATION 7**  
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**ELEVATION 8**  
 SCALE: 1/4" = 1'-0"



**ELEVATION 9**  
 SCALE: 1/4" = 1'-0"



**ELEVATION 10**  
 SCALE: 1/4" = 1'-0"

REVISIONS:

Table with 3 columns: NO., DESCRIPTION, DATE

INDIANA STATE UNIVERSITY THEATER BUILDING DRESSING ROOM / REST ROOM REMODEL

PROJECT DESCRIPTION:

Table with 2 columns: DRAWN BY, DESIGNED BY, SCALE, CHECKED BY, DATE, JOB NO.

SHEET DESCRIPTION:

SYMBOLS, ABBREVIATIONS, & GENERAL NOTES - MECHANICAL

SHEET NUMBER:

PM001

536 N 7th St., Terre Haute, IN 47809


GENERAL NOTES

- 1. THESE NOTES APPLY TO EACH AND EVERY 'M', 'P' AND 'FP' SERIES DRAWINGS.
2. ALL NEW WORK IS DRAWN DARK. ALL WORK DRAWN LIGHT AND FOLLOWED BY (E.) IS EXISTING.
3. ALL WORK SHALL REMAIN UNLESS SPECIFICALLY NOTED OTHERWISE.
4. FIELD VERIFY ALL EXISTING CONDITIONS AS TO EXACT SERVICE, LOCATION, TYPE OF MATERIAL, ETC. BEFORE BIDDING AND BEFORE BEGINNING RENOVATION WORK.
5. COORDINATE ALL SHUT-DOWNS, DELIVERY, AND STORAGE OF MATERIALS, ETC. WITH OWNER'S REPRESENTATIVE.
6. CONTRACTOR SHALL BE RESPONSIBLE FOR COORDINATING WORK WITH ALL OTHER TRADES. SEE SPECIFICATION FOR ADDITIONAL REQUIREMENTS RELATED TO COORDINATION.
7. CONTRACTORS SHALL PROTECT ALL EXISTING OWNER FACILITIES DURING CONSTRUCTION. ANY AND ALL OWNER FACILITIES DAMAGED OR DISCONNECTED BY CONTRACTOR OPERATIONS SHALL BE FULLY RESTORED TO PREVIOUS OPERATING AND APPEARANCE CONDITION BY CONTRACTOR.
8. PROVIDE SLEEVES FOR ALL PIPING AND DUCTWORK THAT PENETRATE WALLS, WHETHER SHOWN OR NOT. HOLES THROUGH EXISTING WALLS TO BE CORE DRILLED OR DRILLED WITH HOLE SAW. SEE SPECIFICATIONS.
9. ALL UNDERLINED EQUIPMENT IS SCHEDULED. SEE M600, P400 AND FP600 SERIES DRAWINGS FOR SCHEDULES.
10. REFERENCE M600, P400 AND FP400 SERIES DRAWINGS FOR TYPICAL AND SPECIFIC INSTALLATION REQUIREMENTS FOR EQUIPMENT, ETC.
11. SMOKING, ALCOHOL, DRUGS, WEAPONS, AND CONTRABAND ARE STRICTLY FORBIDDEN ON JOB SITE PROPERTY.
12. CONTRACTOR SHALL BE RESPONSIBLE FOR CORE DRILLING AND CUTTING HOLES THROUGH WALLS AND FLOORS AS REQUIRED TO INSTALL NEW PIPING AND DUCTWORK, WHETHER SHOWN OR NOT UNLESS SPECIFICALLY NOTED ON 'S' SERIES DRAWINGS.
13. FIELD VERIFY EXACT SIZES OF EXISTING PIPING AND DUCTWORK SYSTEMS SHOWN TO BE CONNECTED TO NEW WORK. IN THE EVENT ACTUAL SIZE IS DIFFERENT THAN SHOWN ON DRAWINGS, CONTACT ENGINEER FOR DIRECTION PRIOR TO ANY WORK.
14. LOCATE AIR TERMINAL BOXES, VALVES, METERS, GAUGES, DAMPERS, FANS, ETC. ABOVE LAY. IN CEILING OR IN EXPOSED AREAS. ALL ITEMS REQUIRING SERVICE AND VALVES MUST BE ACCESSIBLE.
15. ADHERE ENGRAVED PLASTIC LAMINATE TAGS TO THE ACOUSTICAL LAY-IN CEILING GRID AT ALL LOCATIONS WHERE TERMINAL DEVICES, VALVES, FANS, ETC. ARE LOCATED ABOVE THAT CEILING INDICATING THE EQUIPMENT NOMENCLATURE INSTALLED.
16. DO NOT INSTALL DEVICES WHICH REQUIRE SERVICE BEHIND WALLS OR PLASTER CEILINGS OR BAR JOISTS.
17. ALL PLUMBING AND MECHANICAL PIPING AND INSULATION MATERIALS INSTALLED IN CEILING RETURN AIR PLENUMS SHALL COMPLY WITH ASTM E84 FOR FLAME-SPREAD RATING OF 25 OR LESS AND SMOKE-DEVELOPED RATING OF 50 OR LESS.
18. COLORS OF EXPOSED UNITS SHALL BE SELECTED BY ARCHITECT. COLORS SHALL BE MANUFACTURER'S STANDARD OR CUSTOM COLOR AS REQUESTED. SUBMIT COLOR CHARTS WITH SHOP DRAWINGS.
19. SEE 'A' SERIES DRAWINGS FOR WALL AND CEILING REMOVAL AND REPLACEMENT TO INSTALL DUCTWORK, EQUIPMENT, AND PIPING. IF MORE WALL OR CEILING REMOVAL IS REQUIRED THAN SHOWN ON 'A' SERIES DRAWINGS, THEN CONTRACTOR REQUIRING THE DEMOLITION SHALL BE RESPONSIBLE FOR WALL/CEILING REMOVAL AND REPLACEMENT.
20. FOR WALLS THAT GO TO DECK, REFERENCE THE 'A' SERIES DRAWINGS. CONTRACTOR SHALL PROVIDE ACOUSTIC SEALANT AROUND ALL DUCT AND PIPE PENETRATIONS THROUGH FULL HEIGHT WALLS.
21. ADDITIONAL GENERAL NOTES SPECIFIC TO A PARTICULAR DRAWING ARE NOTED ON THOSE DRAWINGS.


ABBREVIATIONS

Table listing abbreviations and their meanings: AD AREA DRAIN, AFC AUTOMATIC FLOW CONTROL, AFF ABOVE FINISHED FLOOR, AHR AIR HOSE REEL, AHU AIR HANDLING UNIT, ALT ALTERNATE, AP ACCESS PANEL, AS AIR SEPARATOR, BD BLOWDOWN, BRD BACKDRAFT PRESSURE RELIEF DAMPER, BTU BRITISH THERMAL UNIT, BV BALANCE VALVE, CB CATCH BASIN, CI CAST IRON, CL CENTERLINE, CO CLEANOUT, CF CLOSET FLANGE, COND CONDENSATE, CONV HYDRONIC CONVECTOR, CUH CABINET UNIT HEATER, CW COLD WATER, DB DRY BULB, DF DRINKING FOUNTAIN, DIA DIAMETER, DIFF DIFFUSER, DOWNSPOUT, DS DIRECT EXPANSION COOLING COIL, DXC, EA EXHAUST AIR, EAT ENTERING AIR TEMPERATURE, EBBR ELECTRIC BASEBOARD RADIATION, EC ELECTRICAL CONTRACTOR, EG EXHAUST GRILLE, EICONV ELECTRIC CONVECTOR, ECUH ELECTRIC CABINET UNIT HEATER, EF EXHAUST FAN, ELEC ELECTRICAL, ELEV ELEVATION, EOM END OF MAIN DRIP, EPUH ELECTRIC PROPPELLER UNIT HEATER, ERCP ELECTRIC RADIANT CEILING PANEL, ESP EXTERNAL STATIC PRESSURE, EWC ELECTRIC WATER COOLER, EWH ELECTRIC WATER HEATER, EXP T EXPANSION TANK, E, ETR EXISTING TO REMAIN, FD FLOOR DRAIN OR FIRE DAMPER, FS FLOOR SINK, FPVAV FAN POWERED VAV, FOB FLAT ON BOTTOM, FSD COMBINATION FIRE/SMOKE DAMPER, FTR HYDRONIC FINNED TUBE RADIATION, GC GENERAL CONTRACTOR, GEN GENERAL, HB HOSE BIBB, HTG HEATING, HW HOT WATER, HWR HOT WATER RETURN, HYD WALL HYDRANT, ID INTERNAL DIAMETER, INV. EL. INVERTED ELEVATION, LAT LEAVING AIR TEMPERATURE, LBG LINEAR BAR GRILLE, LBRG LINEAR BAR RETURN GRILLE, LAV LAVATORY, MBH 1000 BTU/HOUR, MECH MECHANICAL, MH MANHOLE, MC MECHANICAL CONTRACTOR, MS MOP SINK, MUV AUTOMATIC MAKE-UP VALVE, NC NORMALLY CLOSED, NO NORMALLY OPEN, OA OUTSIDE AIR, OAD OUTSIDE AIR DAMPER, OBD OPPOSED BLADE DAMPER, OD OUTSIDE DIAMETER, ORD OVERFLOW ROOF DRAIN, OSD OPEN SITE DRAIN, PFHX PLATE AND FRAME HEAT EXCHANGER, PIV POST INDICATOR VALVE, PLBG PLUMBING, PRV PRESSURE REDUCING VALVE, PUH PROPPELLER UNIT HEATER, RA RETURN AIR, RAD RETURN AIR DAMPER, RCP HYDRONIC RADIANT CEILING HEATING PANEL, RCONP REINFORCED CONCRETE PIPE, RD ROOF DRAIN, RECIRC RECIRCULATING RETURN GRILLE, RG RETURN GRILLE, RPZ REDUCED PRESSURE BACKFLOW PREVENTER, RR RETURN REGISTER, RIV ROOF INTAKE VENT, RRV ROOF RELIEF VENT, SA SUPPLY AIR, SAN SANITARY, SD SMOKE DAMPER, SG SUPPLY GRILLE, SHDR SHOWER DRAIN, SK SINK, SR SUPPLY REGISTER, SS STAINLESS STEEL, STHX SHELL AND TUBE HEAT EXCHANGER, TCC TEMPERATURE CONTROL CONTRACTOR, TCP TEMPERATURE CONTROL PANEL, TG TRANSFER GRILLE, TO TO, TP TRANSFER OPENING, TP TRAP PRIMER LINE, TYP TYPICAL, UR URINAL, VAV VARIABLE AIR VOLUME, VCP VETRIFIED CLAY PIPE, VD VOLUME DAMPER, VFD VARIABLE FREQUENCY DRIVE, VS VENT STACK, VSD VARIABLE SPEED DRIVE, VTR VENT THROUGH ROOF, W WASTE, WB WET BULB, WC WATER CLOSET, WS WASTE STACK

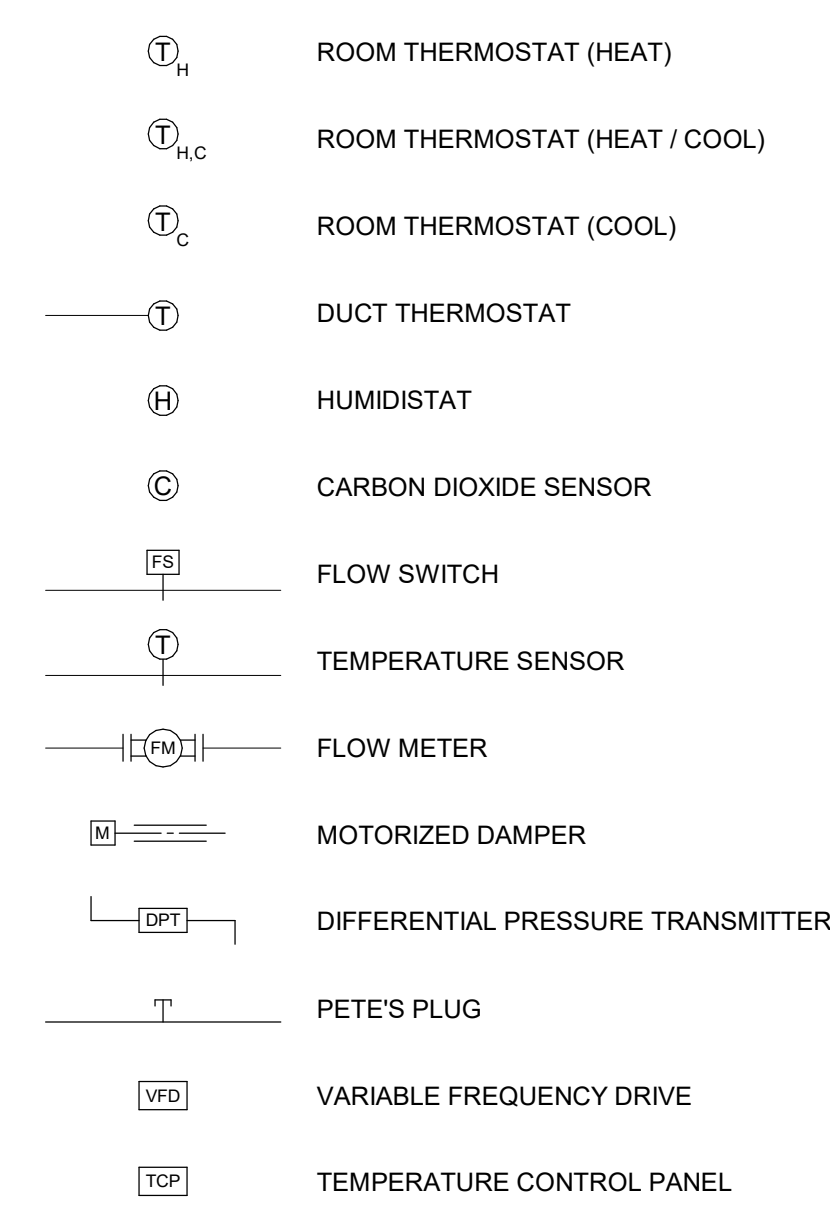
TEMPERATURE CONTROL/MONITORING




DRAWING NOTATIONS

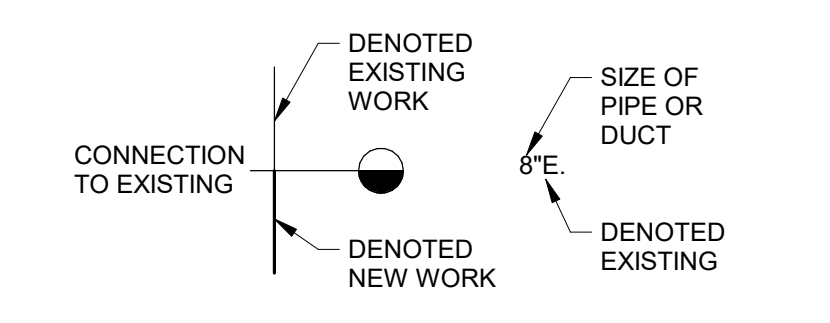


SECTIONS AND DETAILS

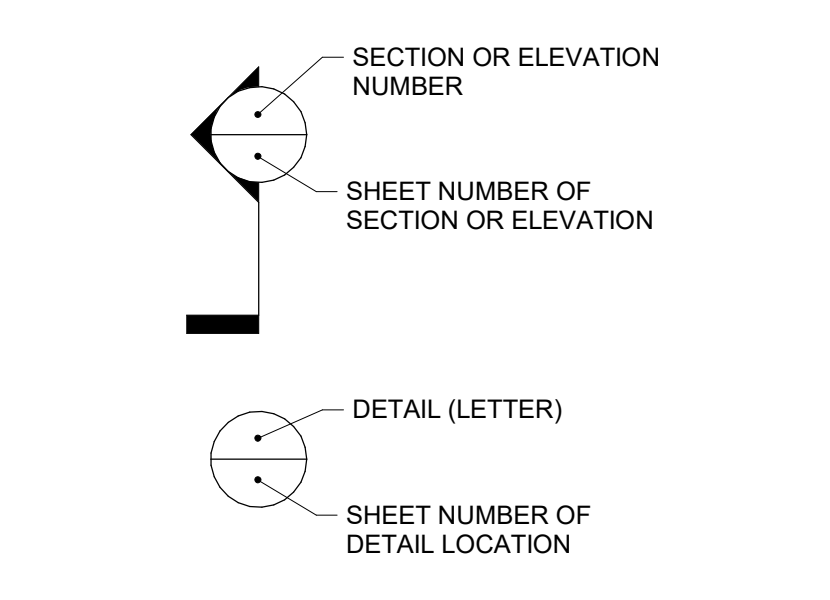


RADIATION SYMBOLS

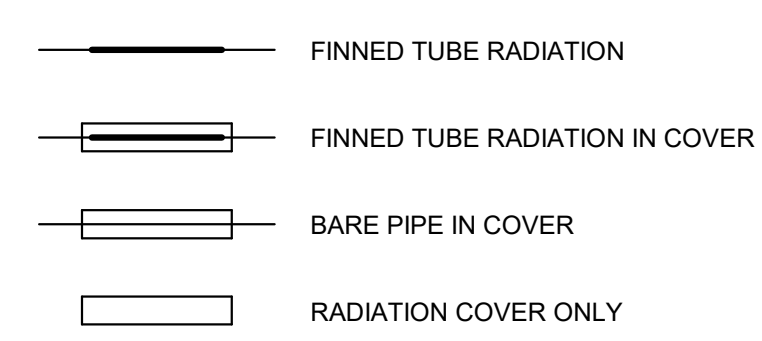

DUCT SYMBOLS

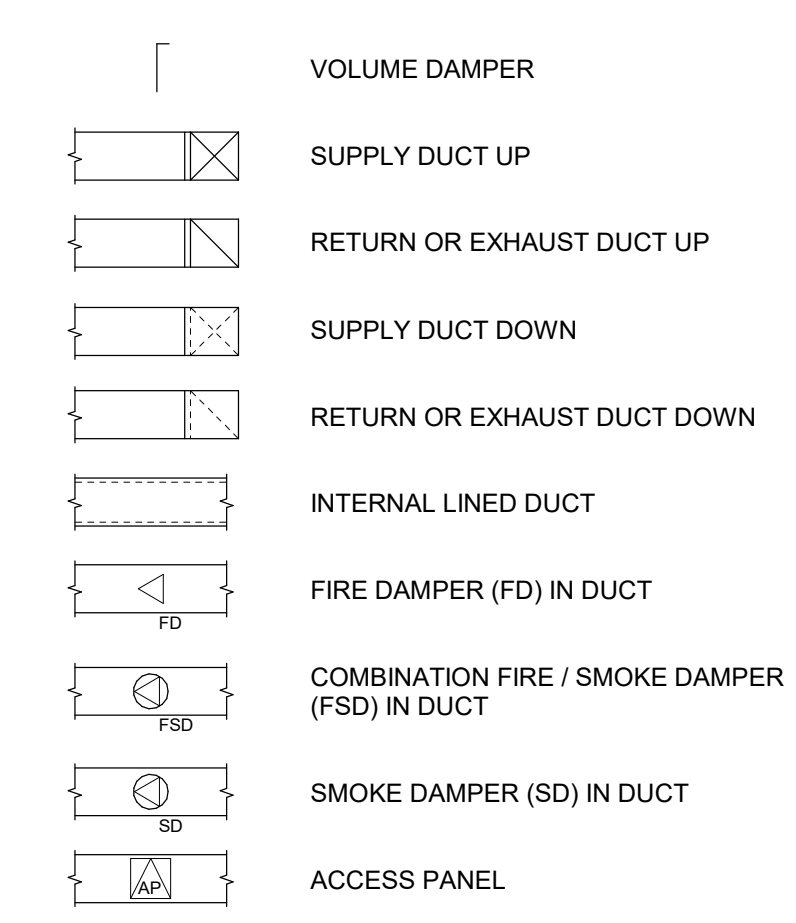


FIRE PROTECTION SYSTEM

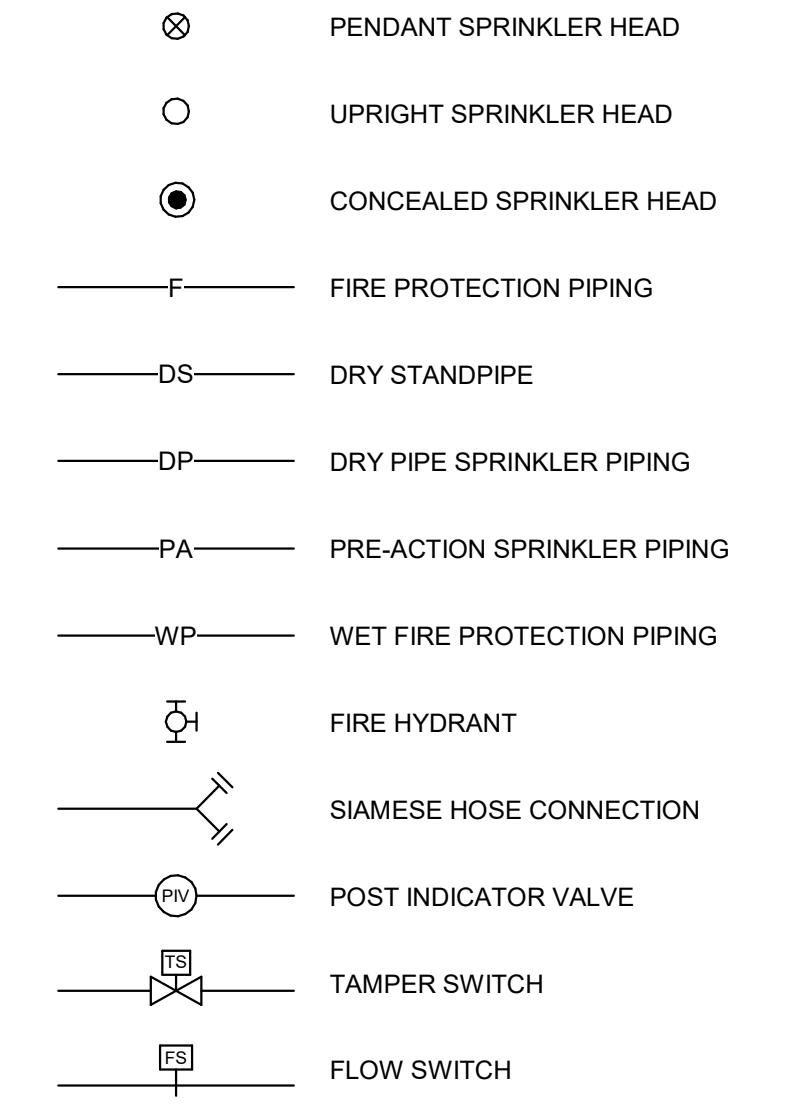


NOMENCLATURE FOR SCHEDULED DEVICES

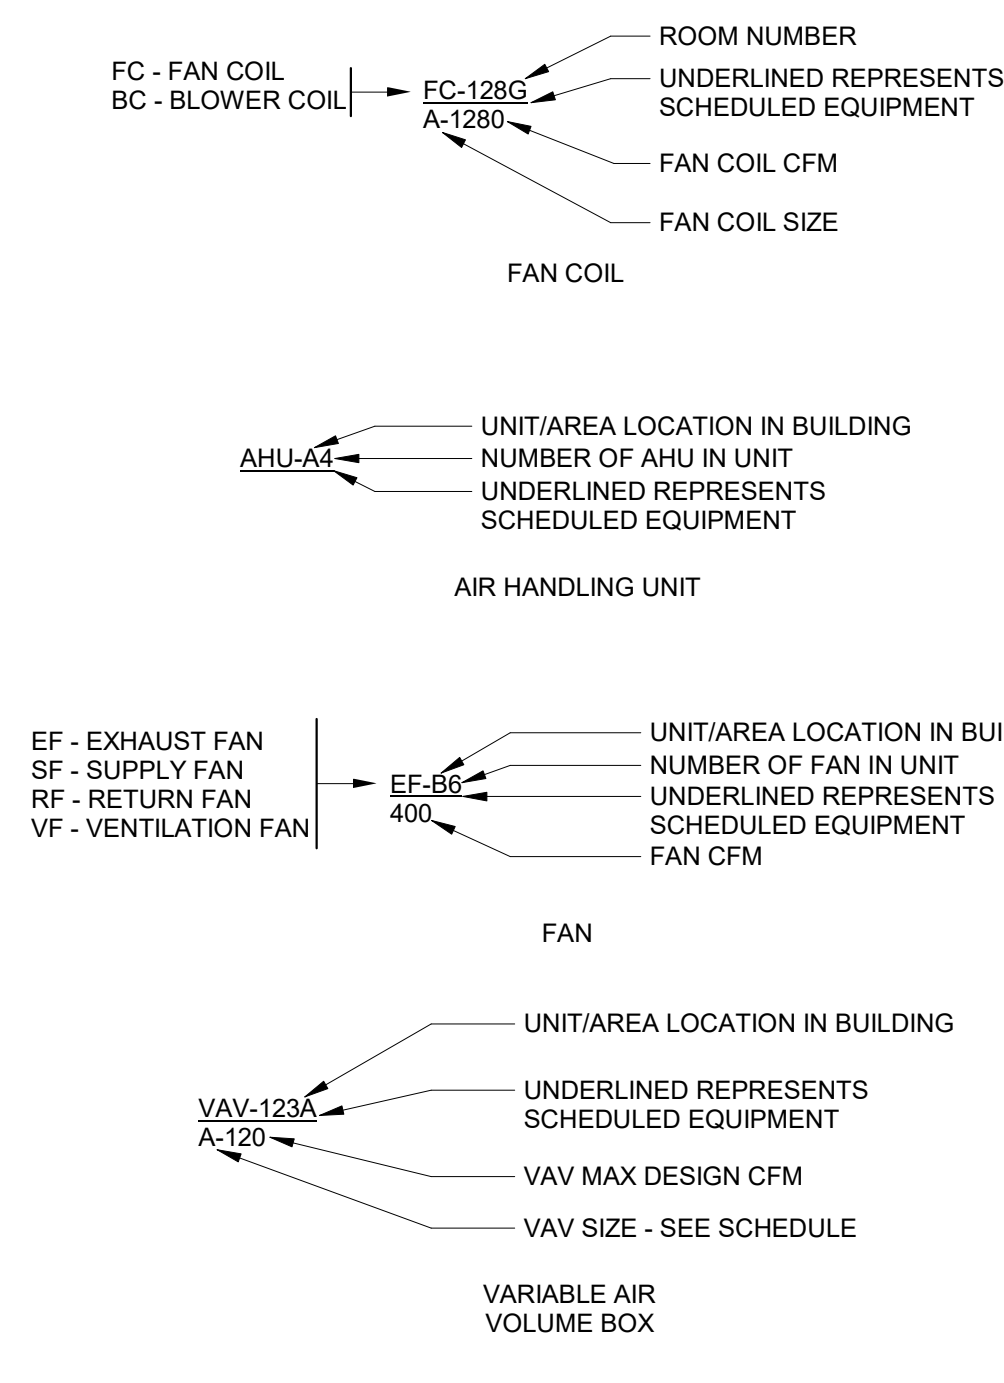
(SEE SCHEDULES M600 SERIES DRAWINGS FOR ADDITIONAL INFORMATION)




STEAM PIPING

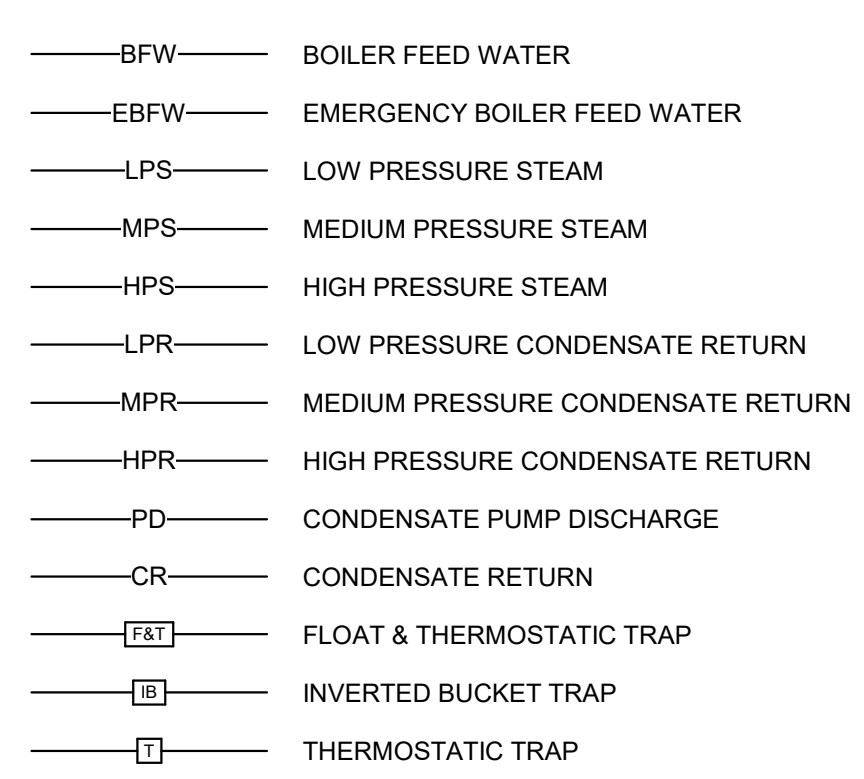


HVAC PIPING

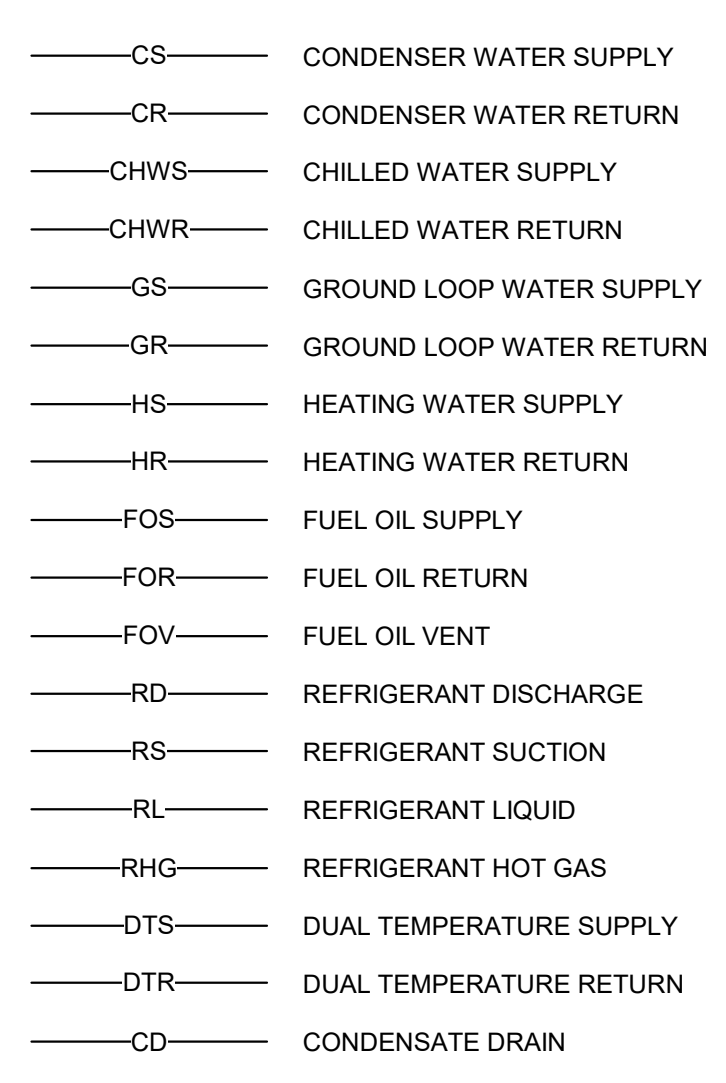


VALVES

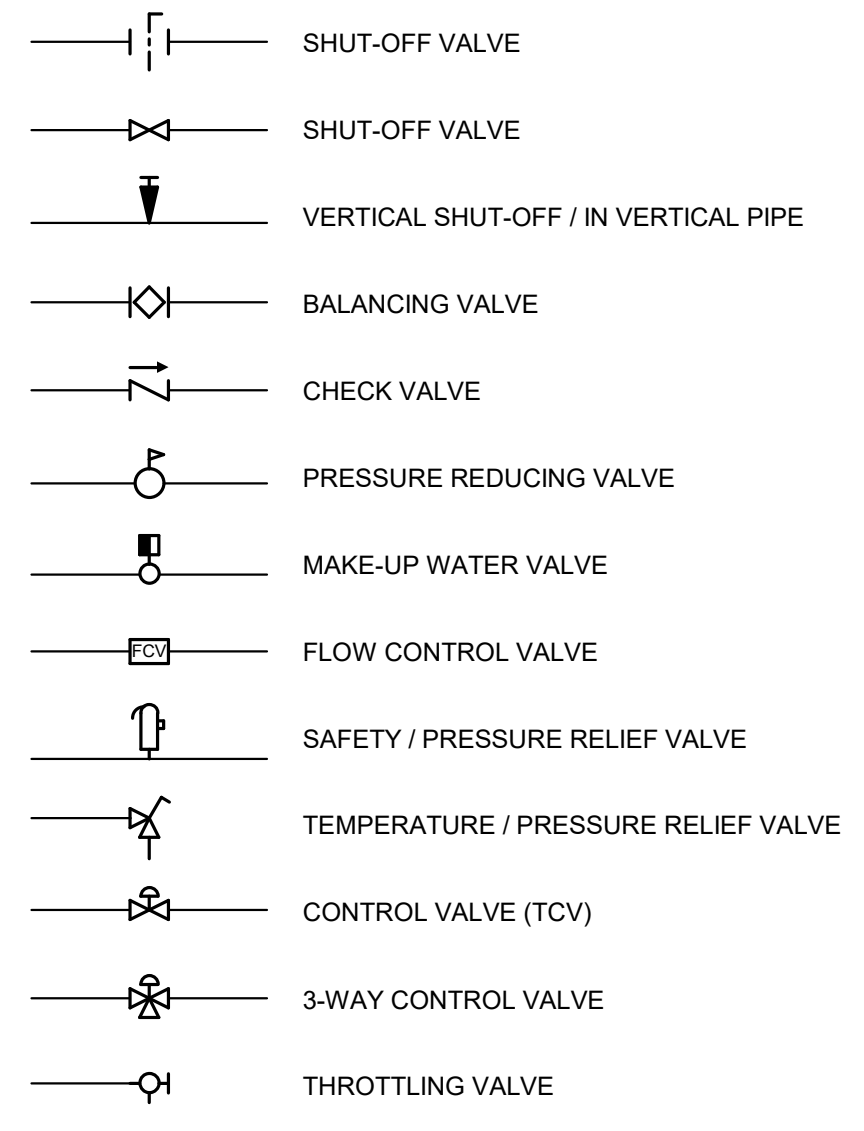


REFRIGERATION VALVES/FITTINGS

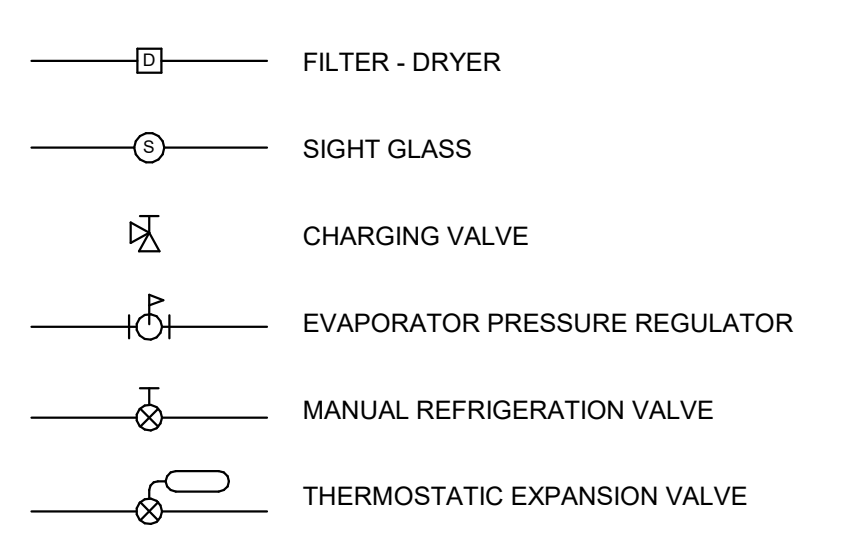

PLUMBING

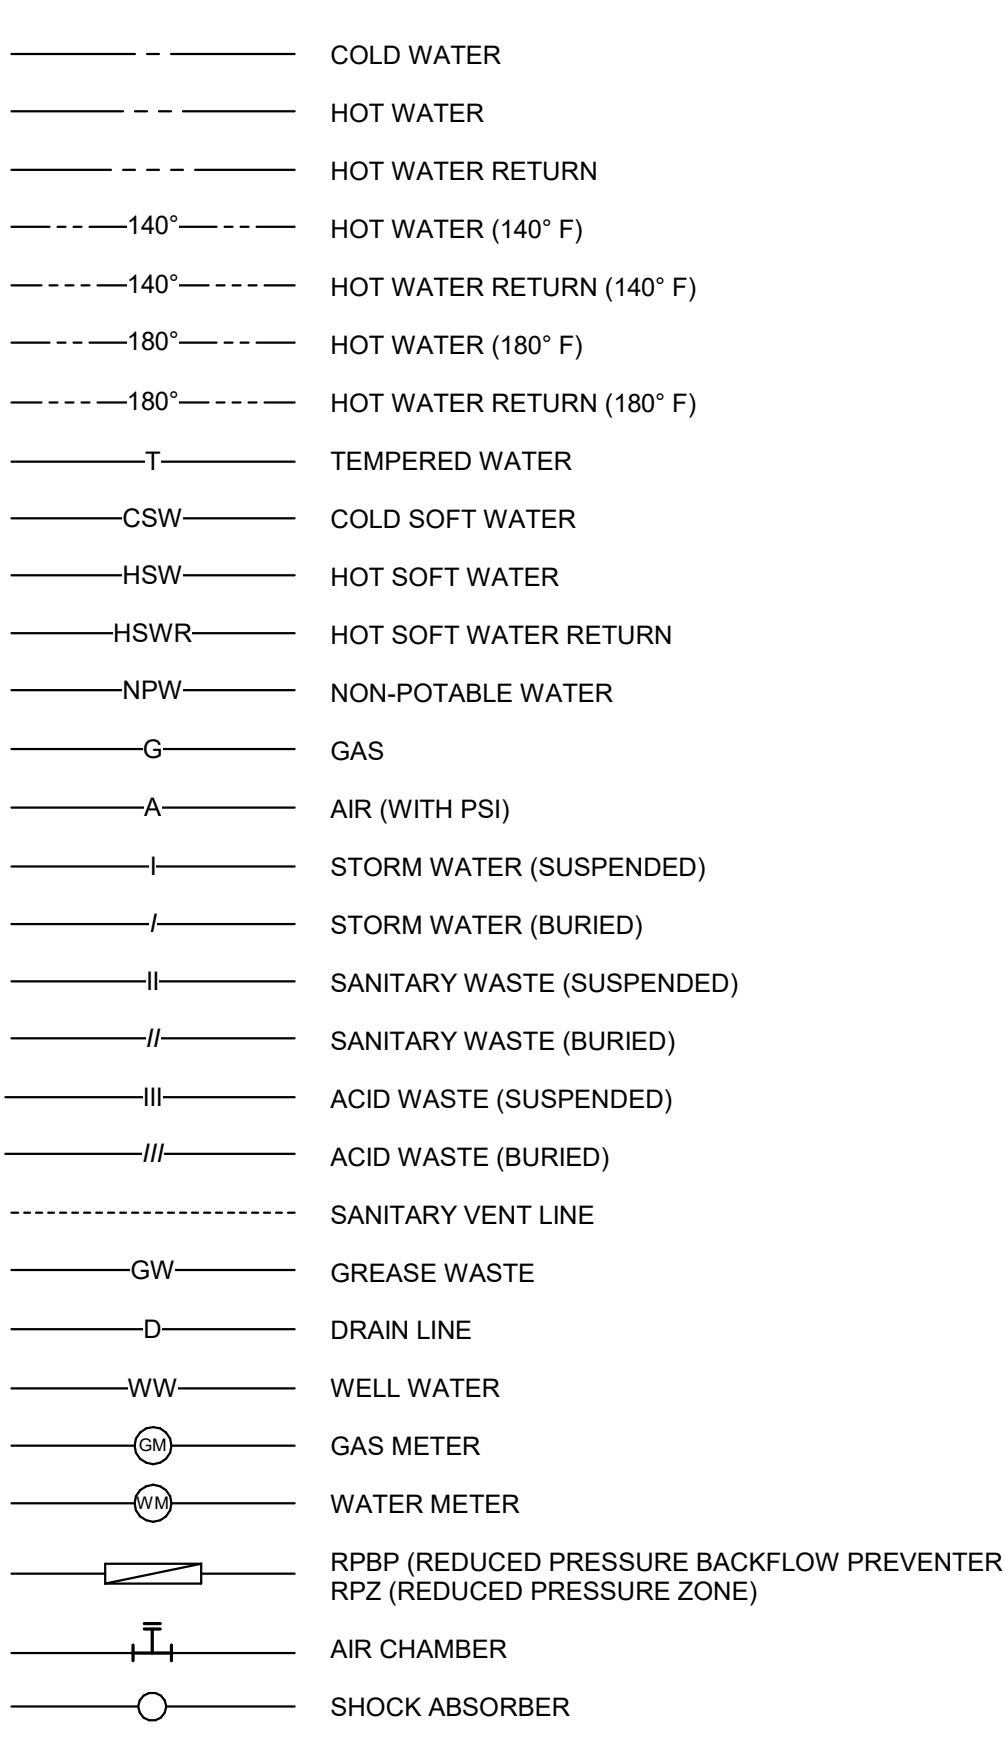

PIPE FITTINGS

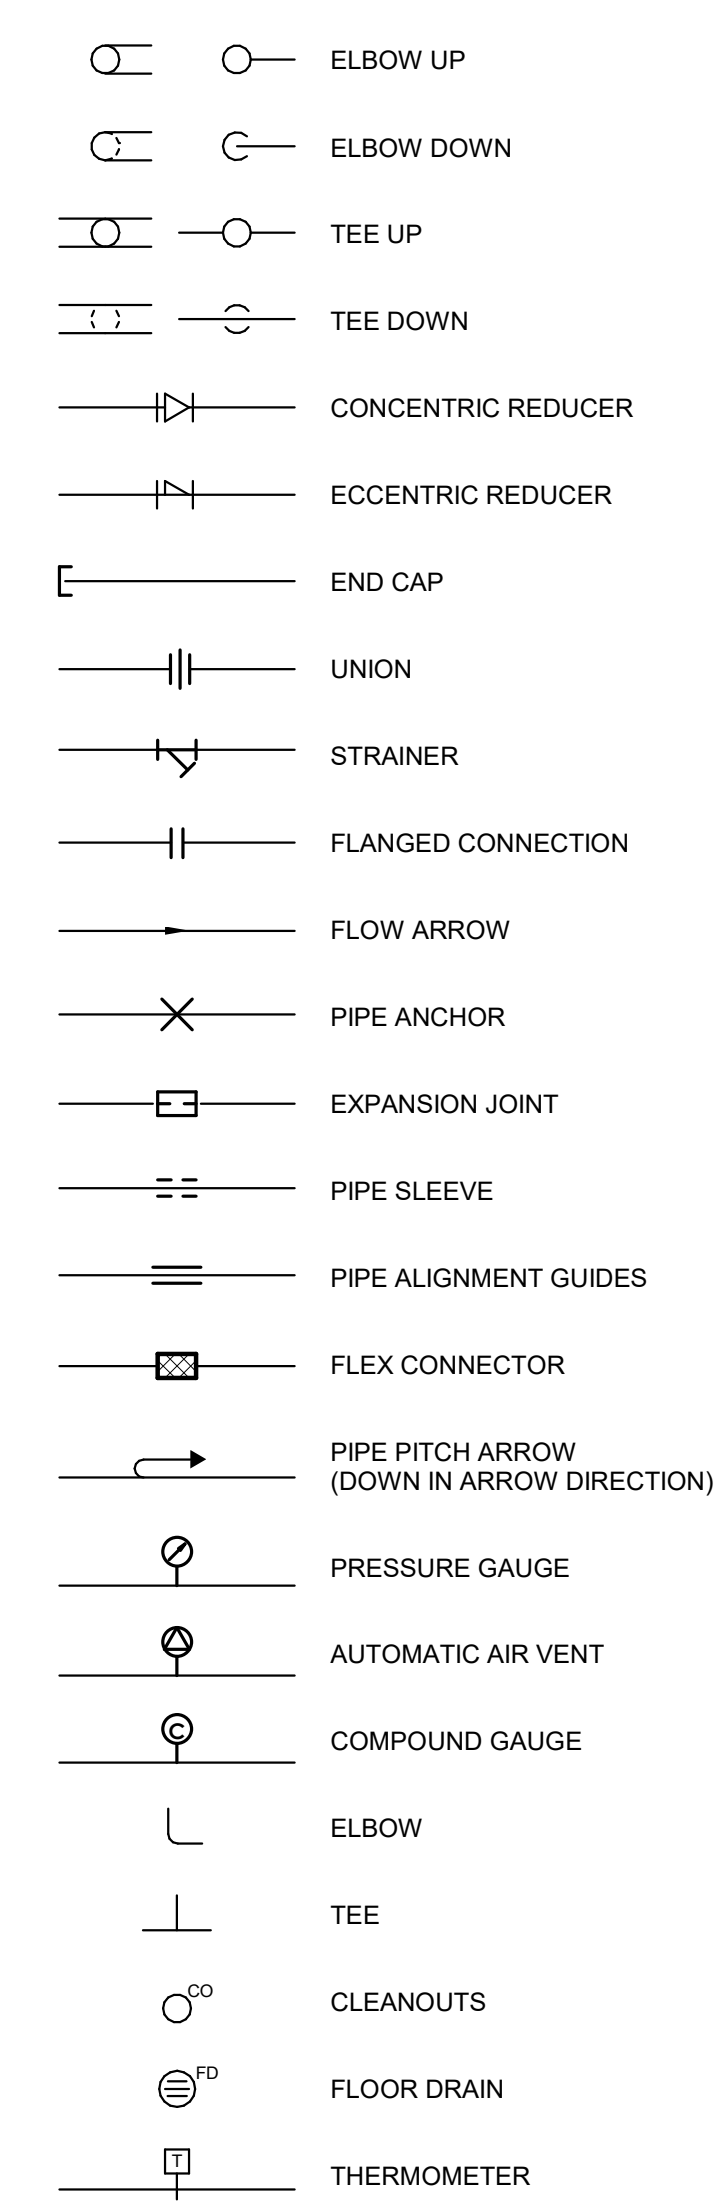

**REVISIONS:**

| NO. | DESCRIPTION | DATE |
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**INDIANA STATE UNIVERSITY**  
**THEATER BUILDING DRESSING ROOM / REST ROOM REMODEL**

536 N 7th St.,  
Terre Haute, IN 47809

PROJECT DESCRIPTION:



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| SCALE:    | REFER TO DRAWING | CHECKED BY:  | MJE   |
| DATE:     | 01/21/2025       | JOB NO.:     | 24116 |

SHEET DESCRIPTION:  
**FLOOR PLAN - PLUMBING DEMOLITION**

SHEET NUMBER:

**PD201**

**DEMOLITION LEGEND:**

-  WORK TO BE REMOVED
-  WORK TO REMAIN

**GENERAL NOTES:**

- REFER TO SHEET PM001 FOR ADDITIONAL GENERAL NOTES.

**PLAN NOTES:**

- REMOVE 2" WASTE PIPING FROM SHOWER DRAIN ABOVE.
- REMOVE 2" PIPING TO THIS POINT AND CAP.
- REMOVE 2" COLD WATER PIPING BACK TO EXISTING 2" SHUT-OFF VALVE. MAKE EXISTING SHUT-OFF VALVE READY FOR NEW CONNECTION.
- REMOVE 1" COLD WATER PIPING TO THIS POINT. MAKE EXISTING 1" COLD WATER PIPING READY FOR NEW CONNECTION.

**PLAN NOTES:**

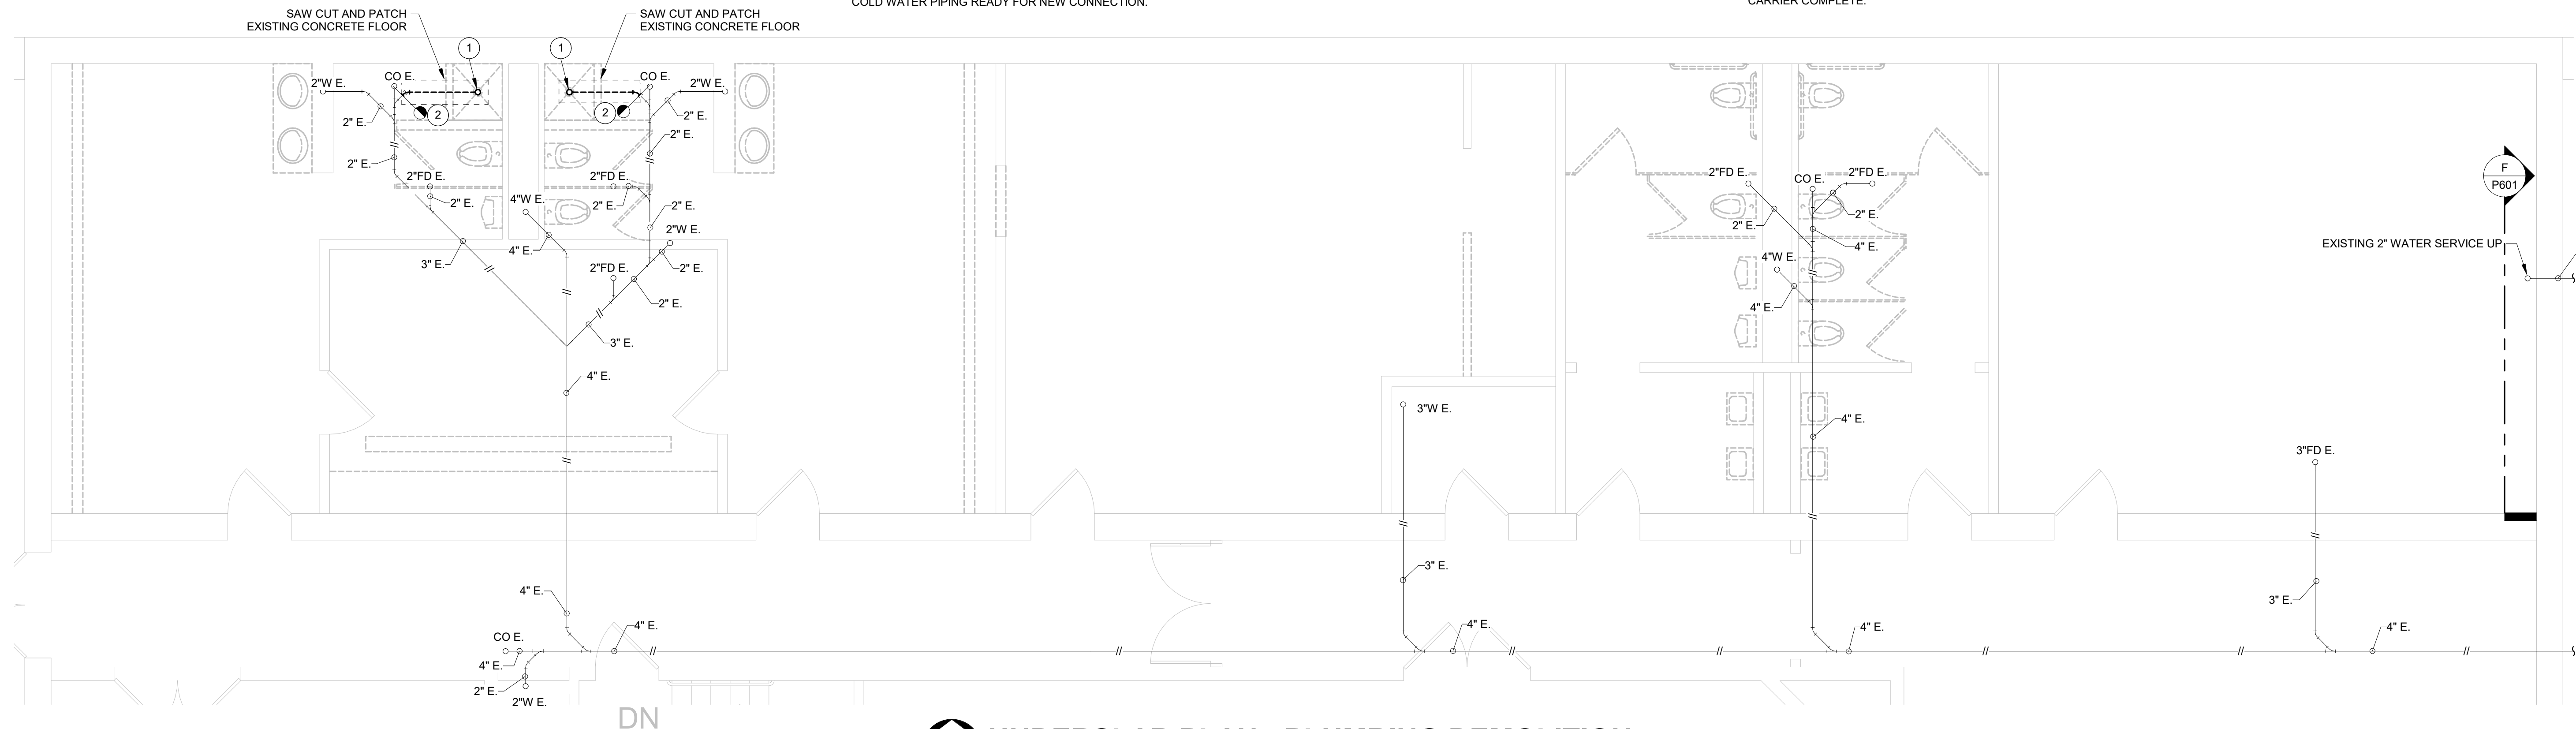
- REMOVE 1" HOT WATER PIPING TO THIS POINT. MAKE EXISTING 1" HOT WATER PIPING READY FOR NEW CONNECTION.
- REMOVE 3/4" HOT RETURN WATER PIPING TO THIS POINT. MAKE EXISTING 3/4" HOT RETURN WATER PIPING READY FOR NEW CONNECTION.
- REMOVE 1" HOT WATER AND 2" COLD WATER PIPING TO THIS POINT. MAKE EXISTING 1" HOT WATER AND 2" COLD WATER PIPING READY FOR NEW CONNECTION.
- REMOVE 3/4" HOT WATER AND 3/4" COLD WATER PIPING TO THIS POINT. MAKE EXISTING 3/4" HOT WATER AND 3/4" COLD WATER PIPING READY FOR NEW CONNECTION.
- REMOVE 3/4" COLD WATER PIPING TO THIS POINT. MAKE EXISTING 3/4" COLD WATER PIPING READY FOR NEW CONNECTION.
- REMOVE 3/4" HOT WATER PIPING TO THIS POINT. MAKE EXISTING 3/4" HOT WATER PIPING READY FOR NEW CONNECTION.
- REMOVE WALL HUNG LAVATORY. REMOVE WATER AND WASTE PIPING BACK TO ROUGH-IN AT WALL. MAKE EXISTING WATER AND WASTE ROUGH-IN READY FOR NEW CONNECTION.

**PLAN NOTES:**


- REMOVE WALL HUNG WATER CLOSET AND FLUSH VALVE. MAKE EXISTING WATER AND WASTE ROUGH-IN READY FOR NEW CONNECTION.
- REMOVE WALL HUNG URINAL AND FLUSH VALVE. MAKE EXISTING WATER AND WASTE PIPING BACK TO WALL AND CAP. ABANDON WATER AND WASTE/VENT PIPING IN EXISTING BLOCK WALL.
- REMOVE LAUNDRY WASHER BOX. ABANDON WATER AND WASTE/VENT PIPING IN EXISTING BLOCK WALL.
- REMOVE 1 1/2" COLD WATER PIPING AND ALL COLD WATER PIPING IN CHASE.
- REMOVE WASTE PIPING IN CHASE BACK TO 4" WASTE STACK. MAKE 4" WASTE STACK READY FOR NEW CONNECTION. REMOVE 2" VENT PIPING IN CHASE BACK TO VENT STACK. MAKE EXISTING 2" VENT PIPING READY FOR NEW CONNECTION. EXISTING 4" VENT THRU ROOF TO REMAIN.
- REMOVE WALL HUNG WATER CLOSET, FLUSH VALVE, AND CHAIR CARRIER COMPLETE.

**PLAN NOTES:**


- REMOVE SHOWER VALVE AND RELATED PIPING COMPLETE.
- REMOVE SHOWER DRAIN.
- REMOVE WATER COOLER. REMOVE WATER AND WASTE PIPING BACK TO WALL. MAKE EXISTING WATER AND WASTE ROUGH-INS READY FOR NEW CONNECTION.



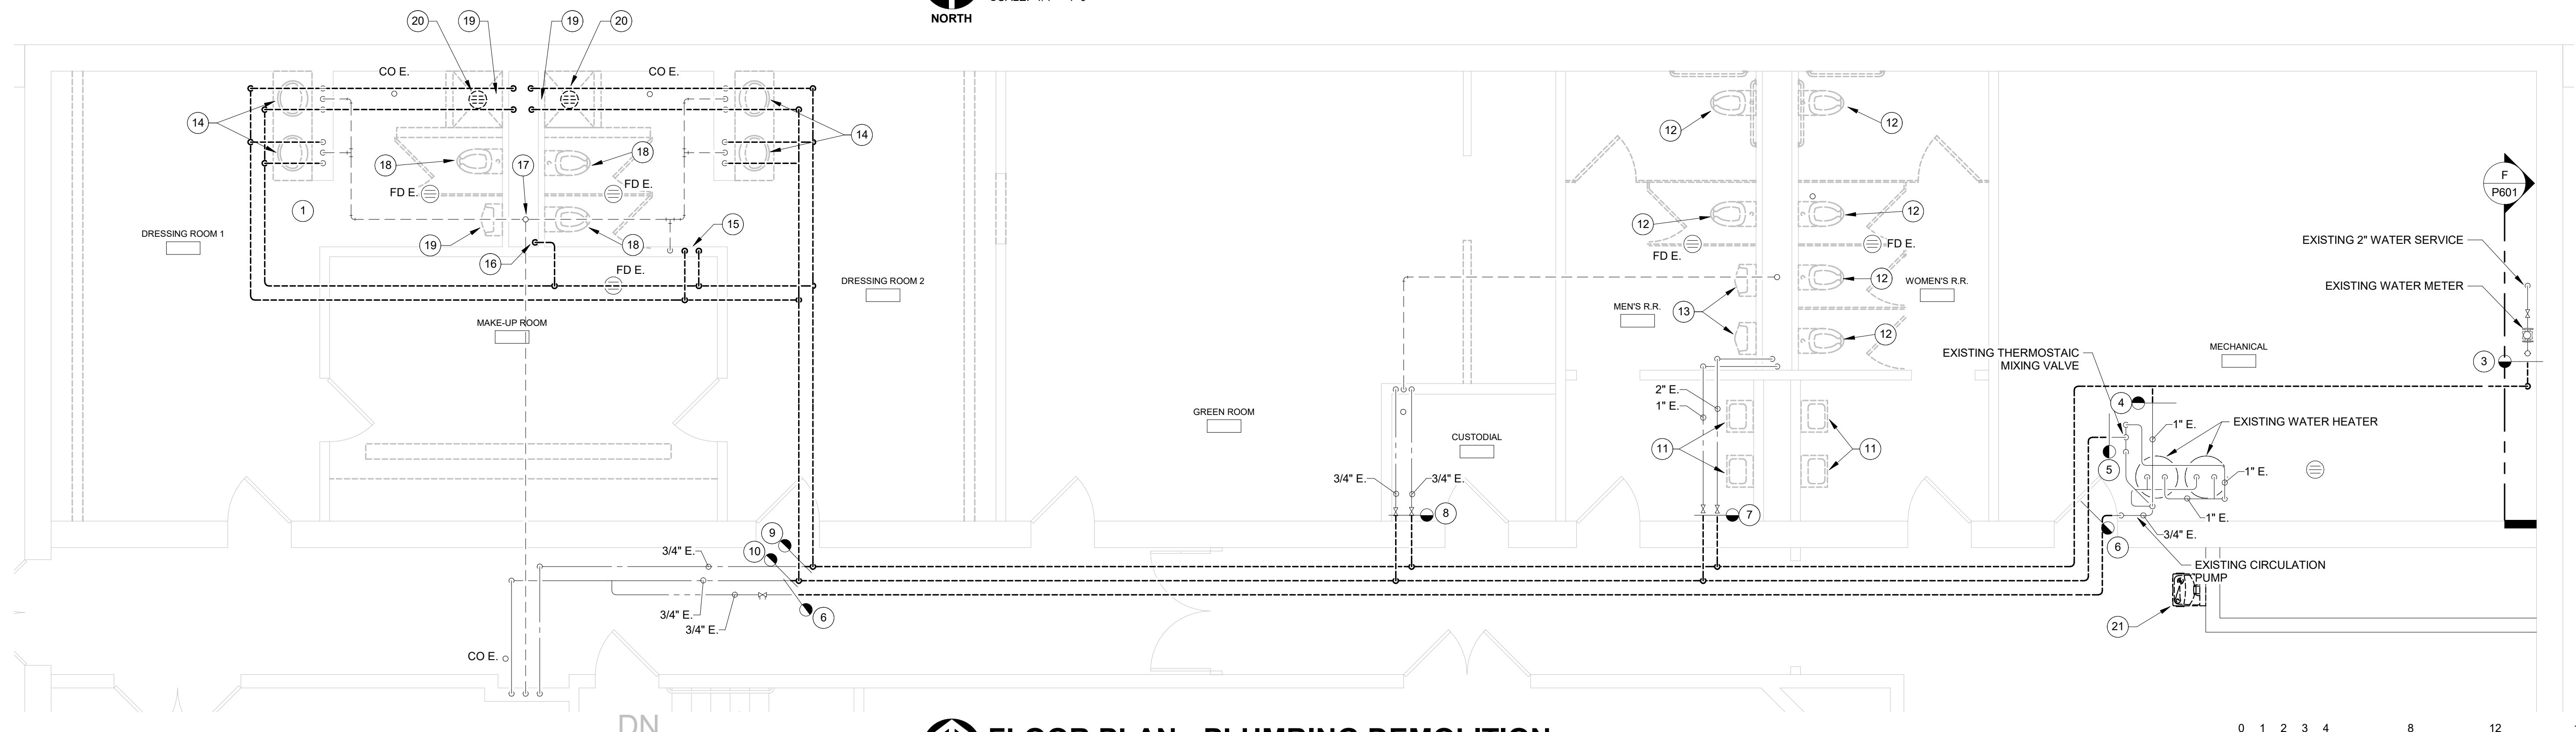**UNDERSLAB PLAN - PLUMBING DEMOLITION**  
SCALE: 1/4" = 1'-0"  
NORTH



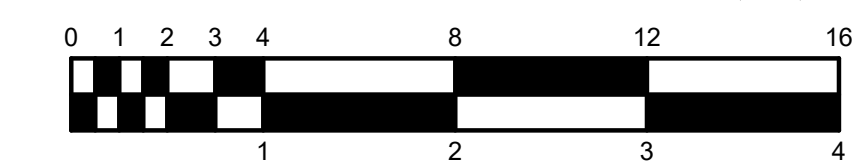**FLOOR PLAN - PLUMBING DEMOLITION**  
SCALE: 1/4" = 1'-0"  
NORTH



REVISIONS:

| NO. | DESCRIPTION | DATE |
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**INDIANA STATE UNIVERSITY**  
**THEATER BUILDING DRESSING ROOM / REST ROOM REMODEL**  
 536 N 7th St.,  
 Terre Haute, IN 47809



PROJECT DESCRIPTION:

|           |                  |              |       |
|-----------|------------------|--------------|-------|
| DRAWN BY: | TJG              | DESIGNED BY: | TJG   |
| SCALE:    | REFER TO DRAWING | CHECKED BY:  | MJE   |
| DATE:     | 01/21/2025       | JOB NO.:     | 24116 |

SHEET DESCRIPTION:  
**FLOOR PLAN - PLUMBING**

SHEET NUMBER:  
**P201**

RENOVATION LEGEND:

-  WORK TO BE INSTALLED
-  WORK TO REMAIN

GENERAL NOTES:

- REFER TO SHEET PM001 FOR ADDITIONAL GENERAL NOTES.

# PLAN NOTES:

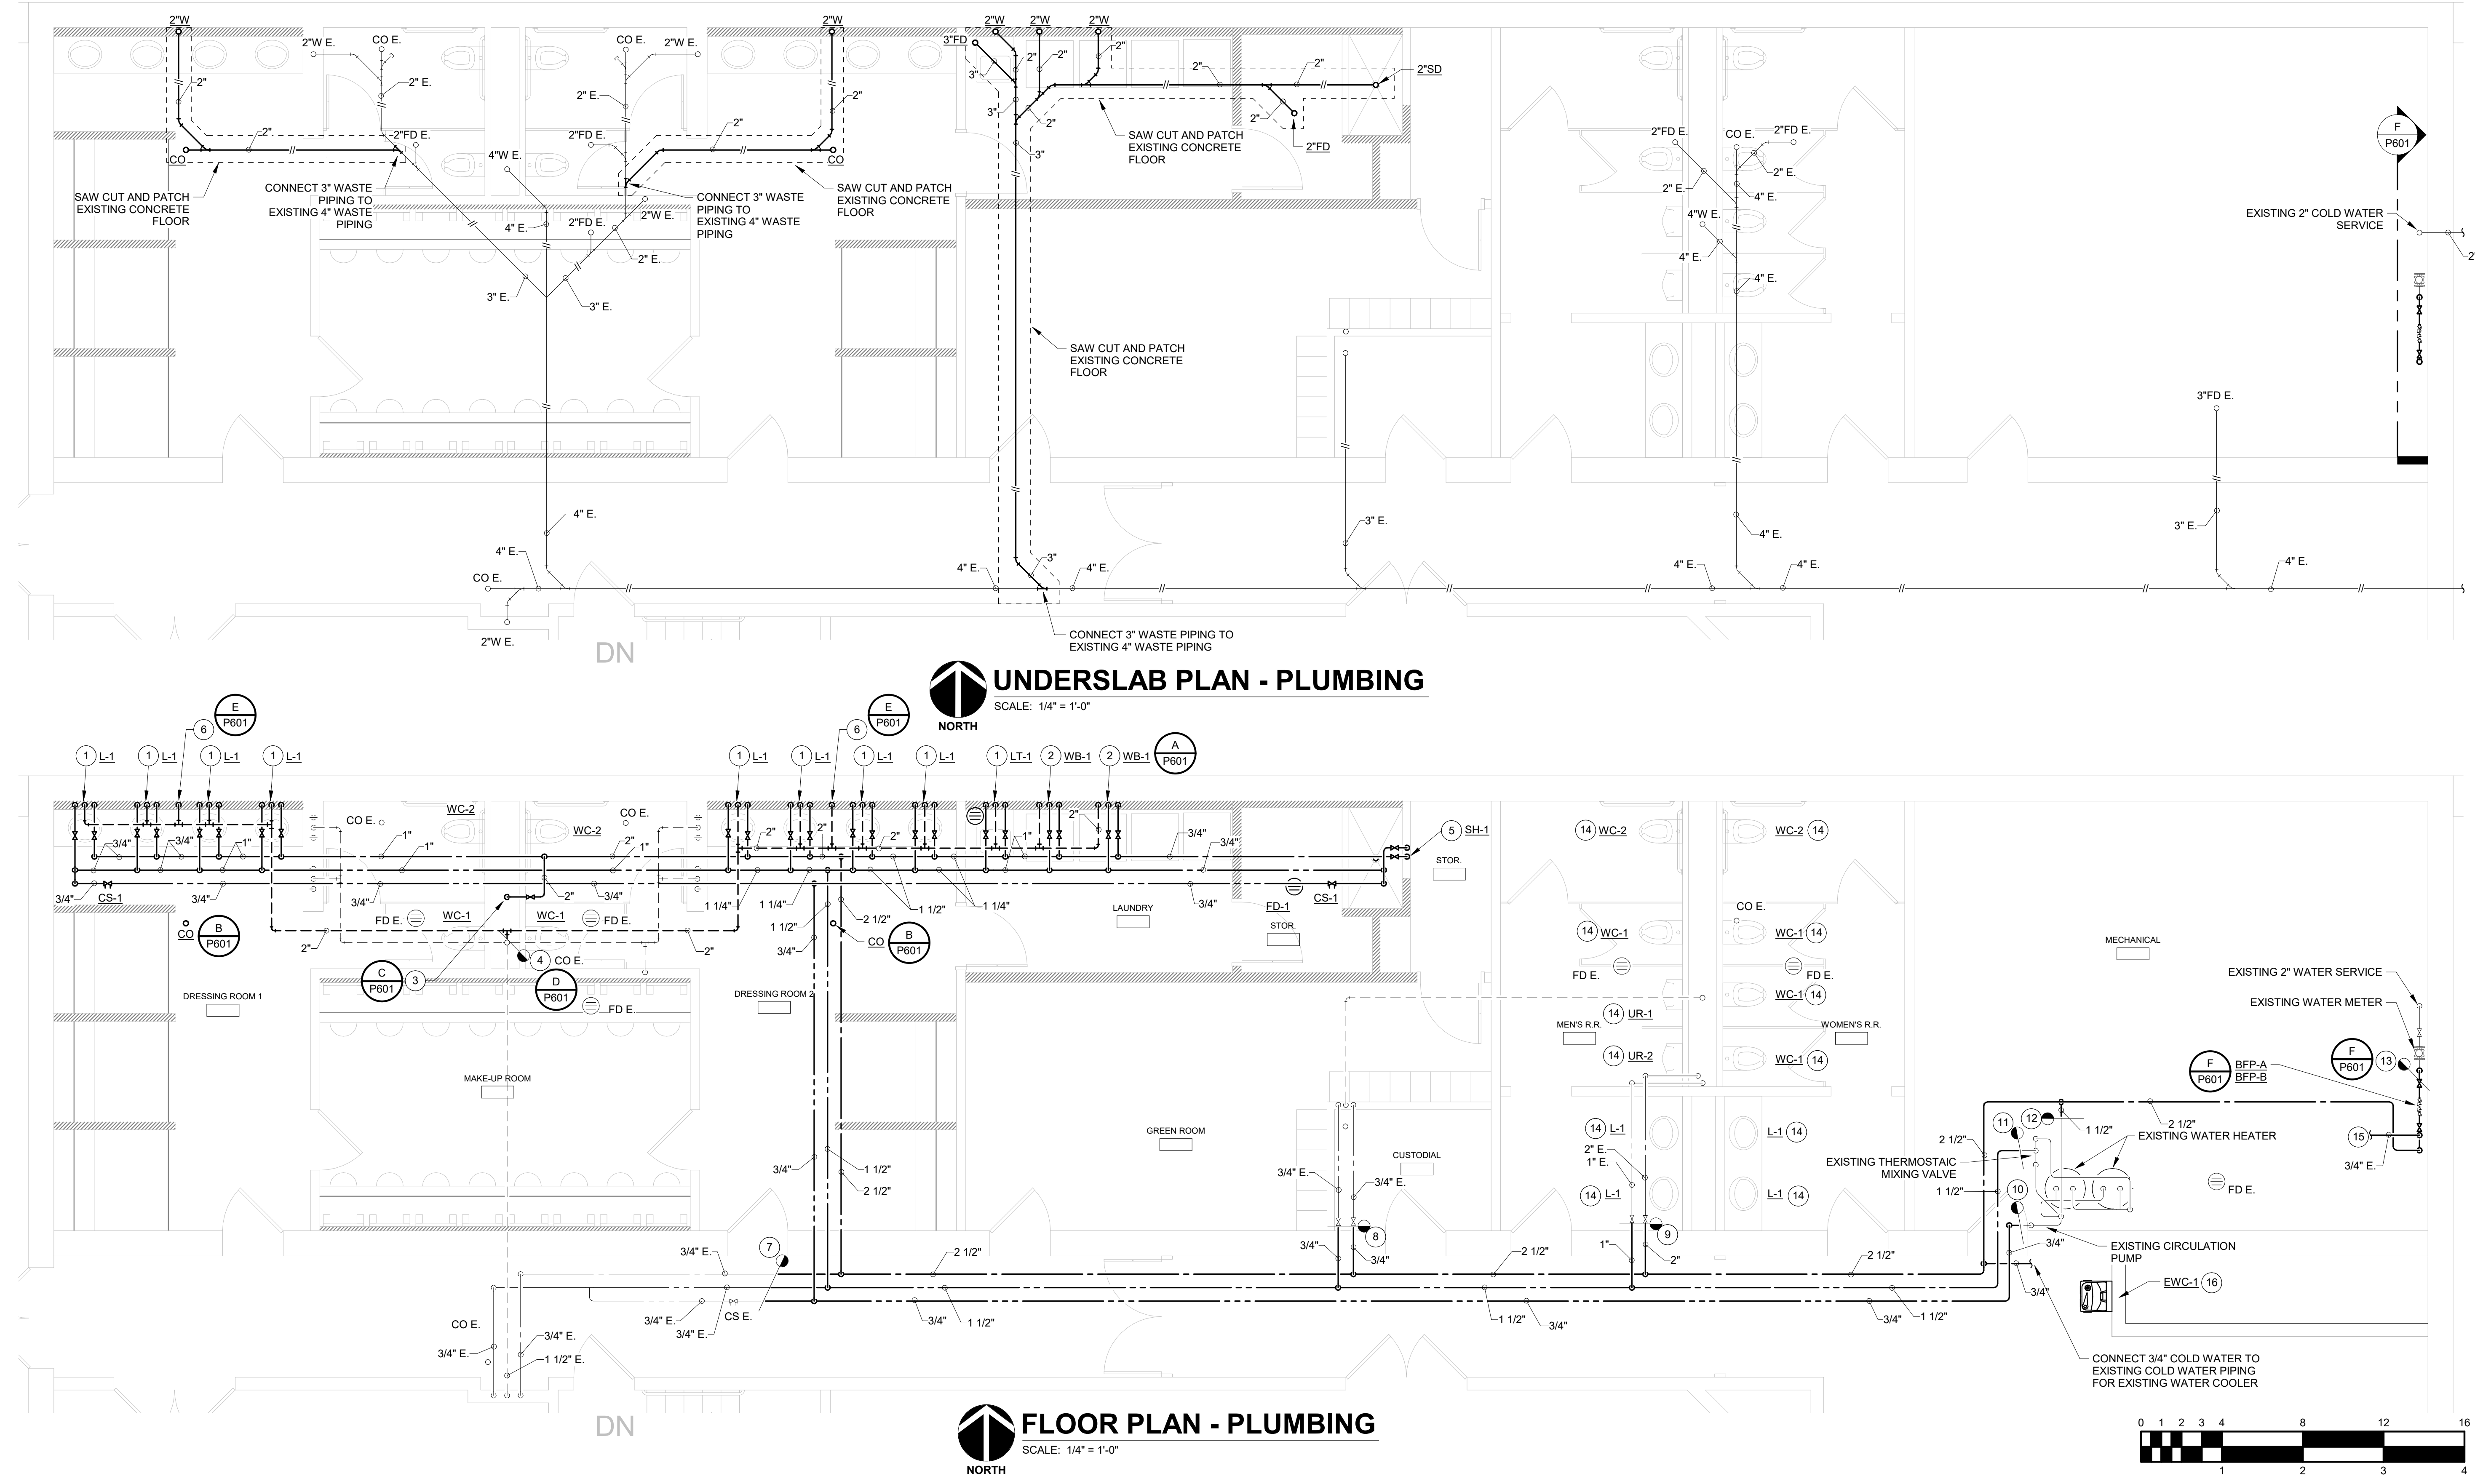
- 3/4" HOT WATER AND 3/4" COLD WATER DOWN. 1 1/2" WASTE DOWN. 1 1/2" VENT UP.
- 3/4" HOT WATER AND 3/4" COLD WATER DOWN. 2" WASTE DOWN. 2" VENT UP.
- 2" COLD WATER DOWN.

# PLAN NOTES:

- CONNECT 2" VENT PIPING TO EXISTING 4" VENT PIPING. EXISTING 4" VENT THRU ROOF.
- 3/4" HOT WATER AND 3/4" COLD WATER DOWN TO SHOWER VALVE.
- 2" WASTE DOWN. 1 1/2" VENT UP.
- CONNECT 3/4" HOT, 3/4" COLD, 3/4" HOT WATER RETURN PIPING TO EXISTING 3/4" HOT, 3/4" COLD, AND 3/4" HOT WATER RETURN PIPING.
- CONNECT 3/4" HOT AND 3/4" COLD PIPING TO EXISTING 3/4" HOT AND 3/4" COLD WATER RETURN PIPING.
- CONNECT 1" HOT AND 2" COLD PIPING TO EXISTING 1" HOT AND 2" COLD WATER RETURN PIPING.
- CONNECT 3/4" HOT WATER RETURN PIPING TO EXISTING 3/4" HOT WATER RETURN PIPING.
- CONNECT 1 1/2" HOT WATER PIPING TO EXISTING HOT WATER PIPING.
- CONNECT 1 1/2" COLD WATER PIPING TO EXISTING COLD WATER PIPING.


# PLAN NOTES:

- CONNECT 2 1/2" COLD WATER PIPING TO EXISTING 2" SHUT-OFF VALVE ON OUTLET SIDE OF EXISTING WATER METER.
- CONNECT PLUMBING FIXTURE WATER AND WASTE SUPPLIES TO EXISTING ROUGH-INS AT WALL.
- CONNECT 3/4" NON POTABLE MAKE UP WATER TO MECHANICAL SYSTEMS. VERIFY IN FIELD EXACT LOCATION OF MAKE UP WATER CONNECTION.
- CONNECT 1/2" COLD WATER AND 1 1/2" WASTE FROM WATER COOLER TO EXISTING WATER AND WASTE ROUGH-INS AT WALL. (ALTERNATE BID)



**UNDERSLAB PLAN - PLUMBING**  
SCALE: 1/4" = 1'-0"  
NORTH

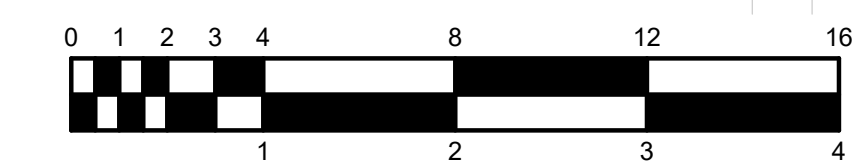**FLOOR PLAN - PLUMBING**  
SCALE: 1/4" = 1'-0"  
NORTH



**REVISIONS:**

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INDIANA STATE UNIVERSITY  
THEATER BUILDING DRESSING ROOM / REST ROOM REMODEL

536 N 7th St.,  
Terre Haute, IN 47809

**PLUMBING EQUIPMENT SCHEDULE**

| MARK NO. | SPECIFICATION NAME | MANUFACTURER & MODEL NO. | ELECTRICAL DATA |       |       | GAS LOAD (BTU) | CAPACITY         | REMARKS |
|----------|--------------------|--------------------------|-----------------|-------|-------|----------------|------------------|---------|
|          |                    |                          | LOAD            | VOLTS | PHASE |                |                  |         |
| BFP-A    | BACKFLOW PREVENTOR | WILKINS #973XL-2"        | -               | -     | -     | -              | 60 GPM @ 10' TDH | -       |
| BFP-B    | BACKFLOW PREVENTOR | WILKINS #973XL-3/4"      | -               | -     | -     | -              | 10 GPM @ 10' TDH | -       |

**FIXTURE ROUGH-IN SCHEDULE & MOUNTING HEIGHTS**

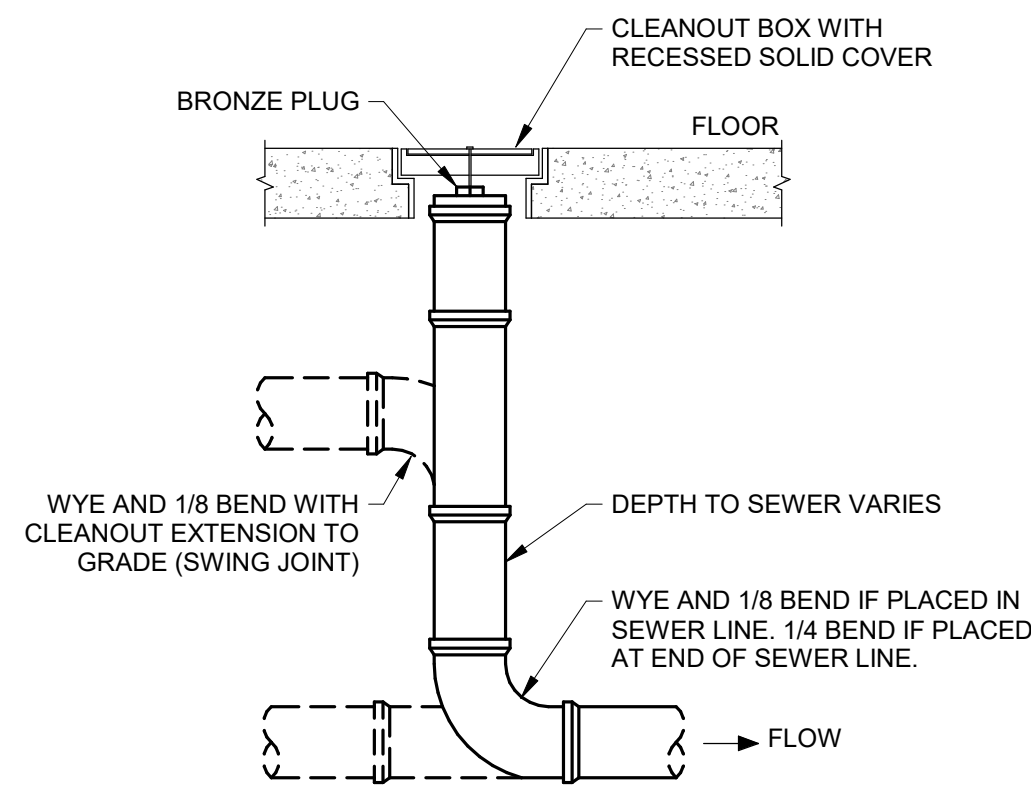
| MARK NO. | FIXTURE DESCRIPTION                             | CW   | HW   | TRAP     | W      | V      | MOUNTING HEIGHTS                                  |
|----------|-------------------------------------------------|------|------|----------|--------|--------|---------------------------------------------------|
| WC-1     | WATER CLOSET - WALL HUNG, FLUSH VALVE           | 1"   | -    | INTEGRAL | 4"     | 2"     | 15" TO SEAT                                       |
| WC-2     | WATER CLOSET - WALL HUNG, FLUSH VALVE, ADA      | 1"   | -    | INTEGRAL | 4"     | 2"     | 17" TO SEAT                                       |
| UR-1     | URINAL - WALL HUNG, FLUSH VALVE                 | 3/4" | -    | INTEGRAL | 2"     | 1-1/2" | 24" TO RIM                                        |
| UR-2     | URINAL - WALL HUNG, FLUSH VALVE, ADA            | 3/4" | -    | INTEGRAL | 2"     | 1-1/2" | 15" TO RIM                                        |
| L-1      | LAVATORY - COUNTER                              | 1/2" | 1/2" | 1-1/2"   | 1-1/2" | 1-1/2" | 34" TO TOP OF DECK                                |
| LT-1     | LAUNDRY TUB                                     | 1/2" | 1/2" | 1-1/2"   | 1-1/2" | 1-1/2" | 34" TO TOP OF DECK                                |
| WB-1     | CLOTHES WASHER BOX                              | 3/4" | 3/4" | 2"       | 2"     | 1-1/2" | 48" ABOVE FINISH FLOOR                            |
| SH-1     | SHOWER - BY OWNER                               | 1/2" | 1/2" | -        | -      | -      | INSTALL SHOWER AND SHOWER VALVE PROVIDED BY OWNER |
| EWC-1    | WATER COOLER WITH BOTTLE FILLER - ALTERNATE BID | 1/2" | -    | 1 1/2"   | 1 1/2" | 1 1/2" | 36" TO BUBBLER                                    |

**WATER HAMMER ARRESTER SCHEDULE**


| TYPE | I.P.S. | F.U. RATING | J.R. SMITH NO. | WADE NO. | ZURN NO. | REMARKS          |
|------|--------|-------------|----------------|----------|----------|------------------|
| A    | 3/4"   | 1 - 11      | 5005           | W-5      | 100      | P.D.I. CERTIFIED |
| B    | 1"     | 12 - 32     | 5010           | W-10     | 200      | P.D.I. CERTIFIED |
| C    | 1"     | 33 - 60     | 5020           | W-20     | 300      | P.D.I. CERTIFIED |
| D    | 1"     | 61 - 113    | 5030           | W-50     | 400      | P.D.I. CERTIFIED |

**CIRCUIT SETTER SCHEDULE**


| MARK NO. | FLOW RATE (GPM) | QUANTITY | SUBTOTAL |
|----------|-----------------|----------|----------|
| CS-1     | 0.5             | 4        | 2.0      |
| CS-2     | 1.0             | 1        | 1.0      |
| CS-3     | 1.5             | 1        | 1.0      |
| TOTAL    |                 |          | 4.0      |




**B INTERIOR CLEANOUT**  
SCALE: NONE

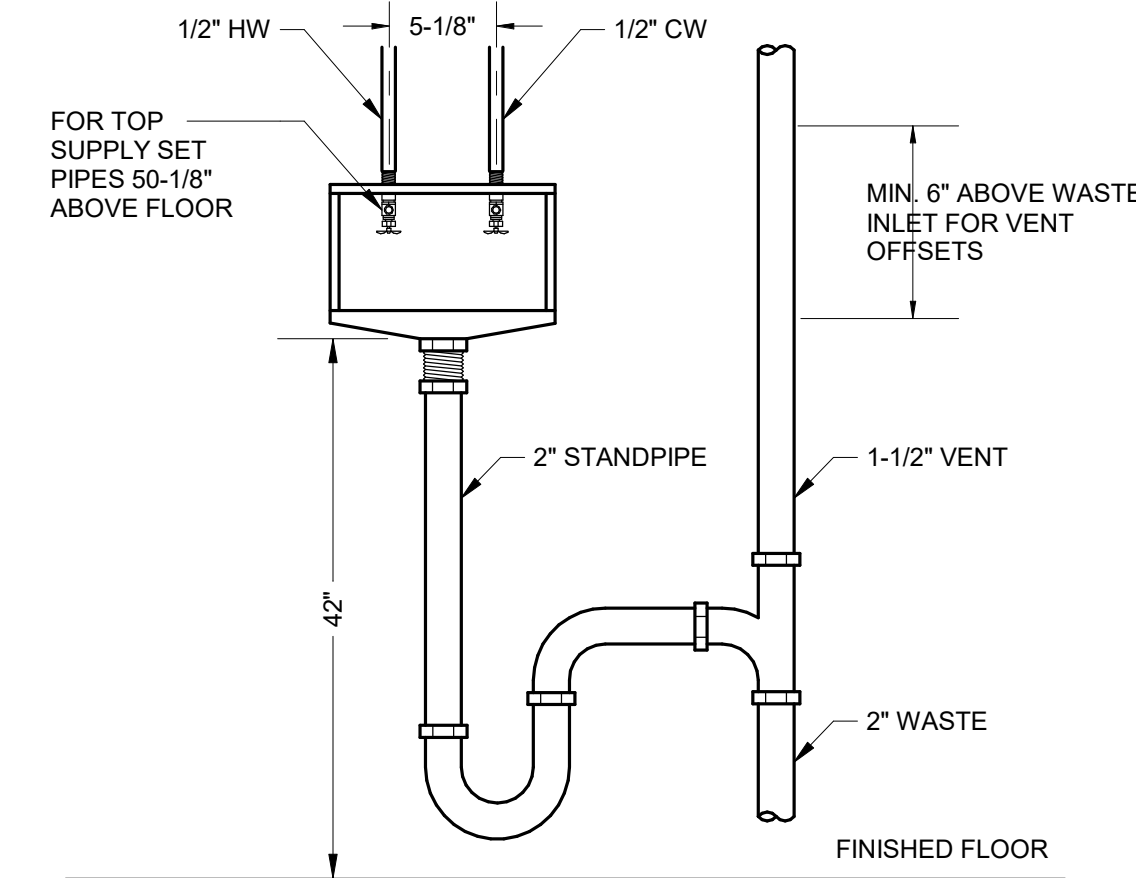


**A WASHER BOX DETAIL**  
SCALE: NONE

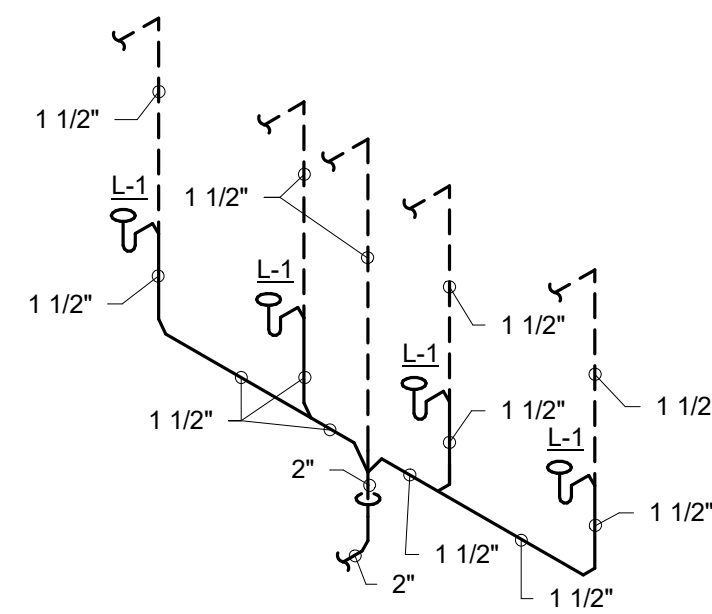

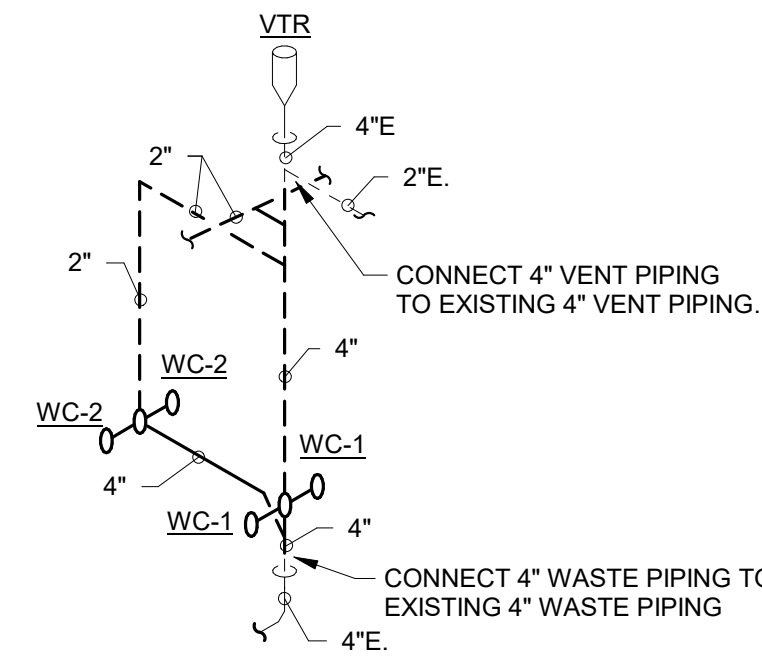
**E WASTE AND VENT DIAGRAM**  
SCALE: NONE



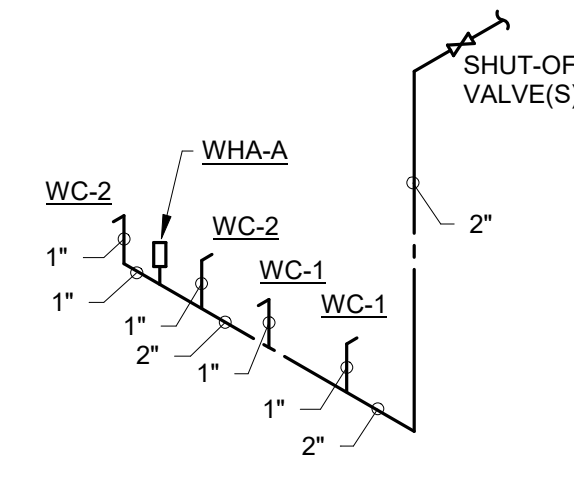**D WASTE AND VENT DIAGRAM**  
SCALE: NONE



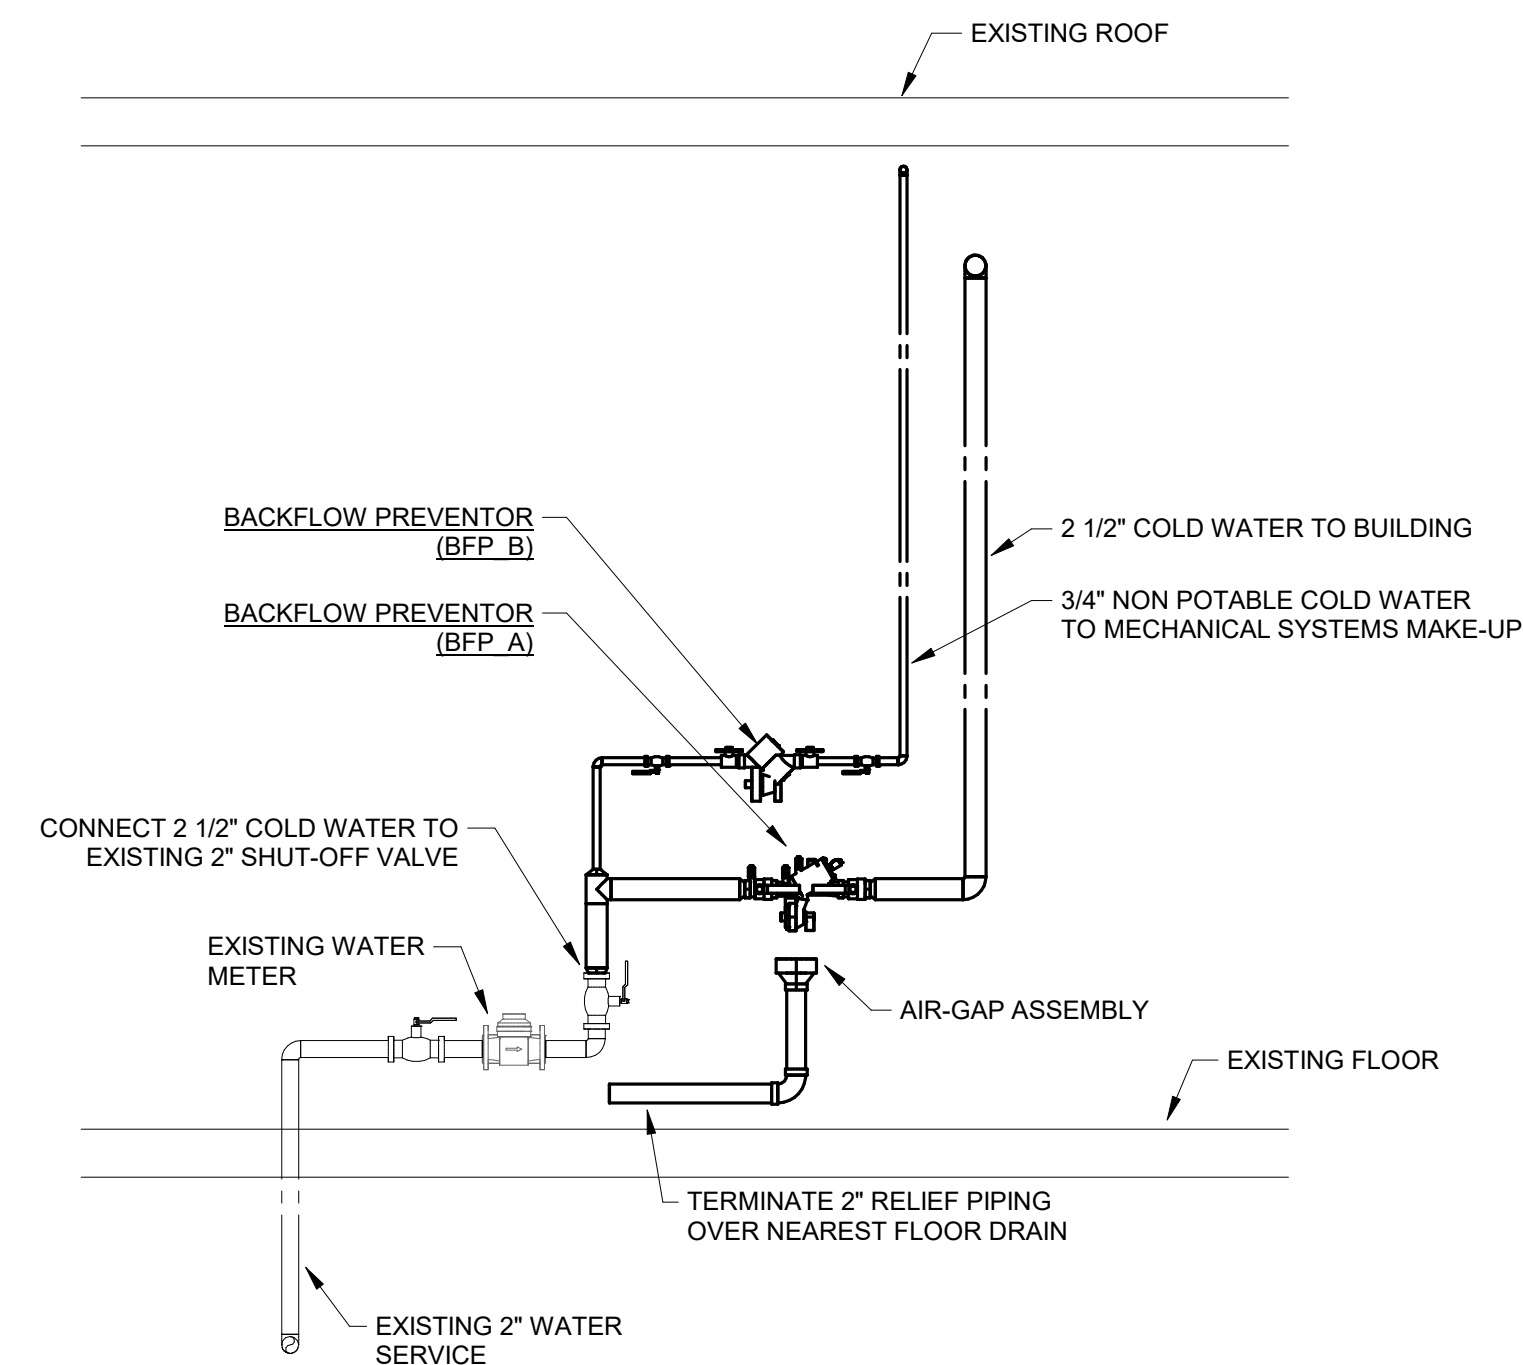**C HOT AND COLD WATER DIAGRAM**  
SCALE: NONE



**F WATER SERVICE DETAIL**  
SCALE: NONE

PROJECT DESCRIPTION:

|                         |                     |
|-------------------------|---------------------|
| DRAWN BY: T.J.G.        | DESIGNED BY: T.J.G. |
| SCALE: REFER TO DRAWING | CHECKED BY: M.J.E.  |
| DATE: 01/21/2025        | JOB NO.: 24116      |

SHEET DESCRIPTION:

**SCHEDULES - PLUMBING**

SHEET NUMBER:



**P601**



REVISIONS:

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RENOVATION LEGEND:

-  WORK TO BE INSTALLED
-  WORK TO REMAIN

GENERAL NOTES:

- THESE NOTES APPLY TO ALL 'FP' SERIES DRAWINGS.
- REFER TO SHEET PM-001 FOR SYMBOLS, ABBREVIATIONS, AND ADDITIONAL GENERAL NOTES.
- CONTRACTOR SHALL BE RESPONSIBLE FOR CORE DRILLING AND CUTTING HOLES THRU WALLS AND FLOORS AS REQUIRED TO INSTALL WORK, WHETHER SHOWN OR NOT.
- ALL PENETRATIONS THRU RATED CONSTRUCTION TO BE FIRE STOPPED. REFER TO LIFE SAFETY PLANS.
- CONTRACTOR SHALL COORDINATE WORK WITH ALL OTHER TRADES PRIOR TO INSTALLATION. CONTACT ENGINEER WITH CONFLICTS OR DISCREPANCIES.
- SPRINKLER SYSTEMS SHALL BE HYDRAULICALLY CALCULATED, FULLY SUPERVISED, AND INSTALLED ACCORDING TO NFPA 13.
- CONTRACTOR SHALL OBTAIN FLOW TEST INFORMATION PRIOR TO DESIGN AND HYDRAULIC CALCULATION OF SPRINKLER SYSTEM.
- ALL SPRINKLER SYSTEM ITEMS REQUIRED BY CODE SHALL BE THE RESPONSIBILITY OF THIS CONTRACTOR WHETHER SHOWN ON THE DRAWINGS AND SPECIFICATIONS OR NOT.

GENERAL NOTES:

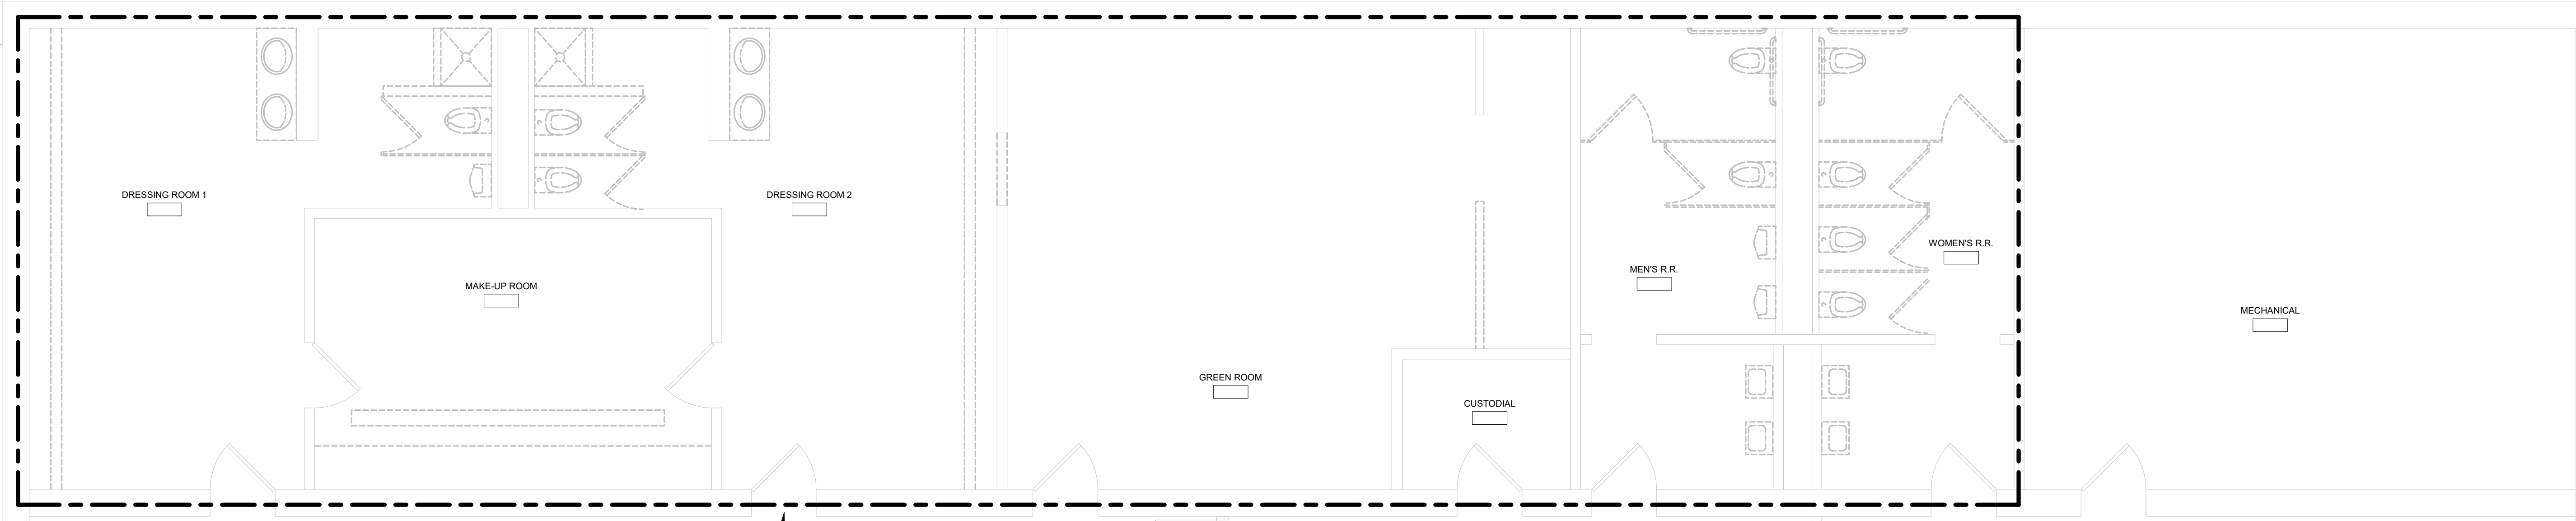
- ALL FIRE PROTECTION SYSTEMS TO BE INSTALLED TO MEET THE REQUIREMENTS OF THE INDIANA FIRE CODE, 2014; THE NATIONAL FIRE PROTECTION ASSOCIATION (NFPA) STANDARD 13, 2010; THE NATIONAL FIRE PROTECTION ASSOCIATION (NFPA) STANDARD 14; AND INDIANA AMENDMENTS (675 IAC-28-1-5).
- PIPE ROUTINGS INDICATED ON DRAWINGS ARE DIAGRAMMATIC AND ARE A SUGGESTED METHOD FOR DESIGN. CONTRACTOR SHALL BE RESPONSIBLE FOR FINAL COORDINATION, LAYOUT, CODE COMPLIANCE, AND DESIGN.
- PROVIDE UPRIGHT SPRINKLER HEADS IN UNFINISHED SPACES (I.E. THOSE WITH EXPOSED STRUCTURE). CONCEALED HEADS IN FINISHED SPACES (I.E. THOSE WITH LAY-IN, DRYWALL, OR DECORATIVE CEILINGS), SIDEWALL HEADS WHERE IMPRACTICAL TO BE INSTALLED CONCEALED OR UPRIGHT TYPE, OR AS INDICATED OTHERWISE ON THE DRAWINGS.
- REFER TO ARCHITECTURAL REFLECTED CEILING PLANS FOR COORDINATION OF CEILING MOUNTED ITEMS.
- ALL NEW WORK IS DRAWN DARK. ALL WORK DRAWN LIGHT AND FOLLOWED BY (E.) IS EXISTING.
- CONTRACTOR SHALL FIELD VERIFY EXISTING PIPE AND EQUIPMENT SIZES, LOCATIONS, ELEVATIONS, MATERIALS, ETC. BEFORE BIDDING OR BEGINNING WORK.

GENERAL NOTES:

- CONTRACTOR SHALL COORDINATE SHUT DOWN OF ANY FIRE PROTECTION SYSTEM THAT AFFECTS OCCUPIED SPACES WITH THE OWNER, OCCUPANTS OF THE AFFECTED AREA, AND ANY OTHER AUTHORITY HAVING JURISDICTION.
- PROVIDE TEMPORARY CAPS AS REQUIRED SO EXISTING SYSTEM WILL REMAIN OPERATIONAL DURING CONSTRUCTION.
- CONTRACTOR SHALL PROTECT ALL EXISTING OWNER FACILITIES DURING CONSTRUCTION. ANY FACILITY DAMAGED OR DISCONNECTED BY CONTRACTOR OPERATIONS SHALL BE FULLY RESTORED TO PREVIOUS OPERATING AND APPEARANCE CONDITION AND AT NO COST TO OWNER.
- REMOVE ALL PIPE, VALVES, ETC. MADE OBSOLETE AS A RESULT OF NEW CONSTRUCTION.
- THOROUGHLY REVIEW ALL DRAWINGS PRIOR TO ANY DEMOLITION WORK. ANY ITEMS REMOVED ACCIDENTALLY MUST BE REPLACED AT NO ADDITIONAL COST TO OWNER.
- DISPOSAL OF DEMOLISHED MATERIALS SHALL COMPLY WITH ALL LOCAL, STATE, AND FEDERAL REGULATIONS.
- NO ABANDONED PIPE, VALVES, FITTINGS, ETC. WILL BE ALLOWED TO REMAIN, UNLESS SPECIFICALLY NOTED OTHERWISE IN DRAWINGS.
- CONTRACTOR SHALL REMOVE, REPLACE, AND/OR RELOCATE EXISTING SPRINKLER SYSTEM AS REQUIRED TO ACCOMMODATE NEW MECHANICAL NEEDS.


PLAN NOTES:

- REMOVE SPRINKLER HEAD AND ARM OVER PIPING BACK TO EXISTING BRANCH SPRINKLER MAIN. MAKE EXISTING BRANCH SPRINKLER MAIN READY FOR NEW CONNECTION.
- CONNECT ARM OVER PIPING TO EXISTING BRANCH SPRINKLER MAIN AND CONNECT TO NEW CONCEALED SPRINKLER HEAD. INSTALL SPRINKLER HEAD IN CENTER OF TILE. COORDINATE LOCATION OF SPRINKLER HEAD WITH ALL CEILING MOUNTED DEVICES.




FLOOR PLAN - FIRE PROTECTION DEMOLITION

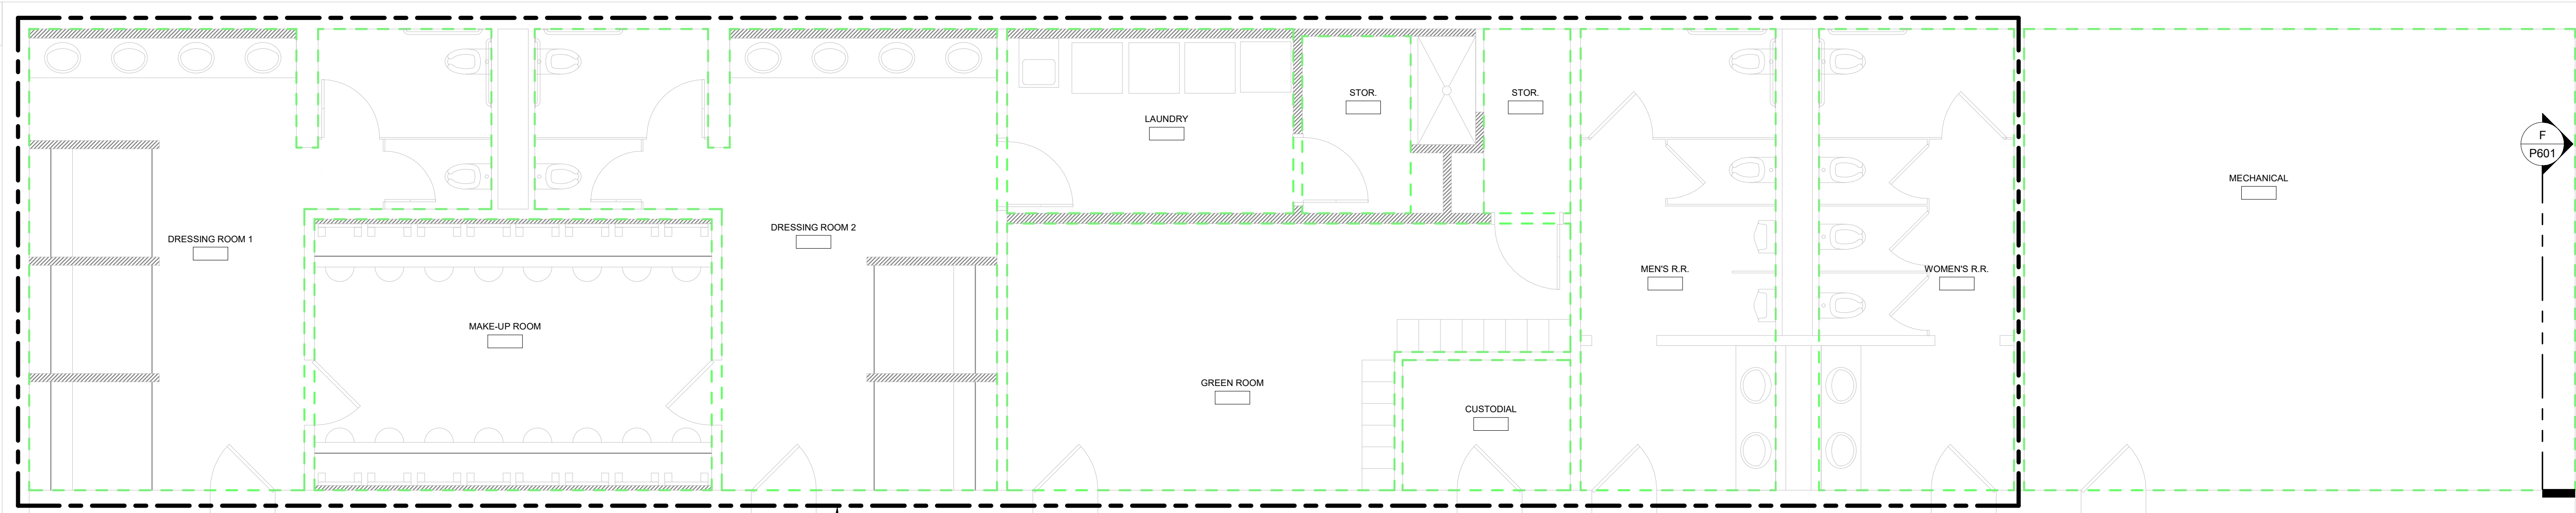SCALE: 1/4" = 1'-0"



FLOOR PLAN - FIRE PROTECTION

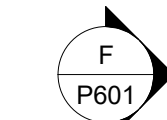SCALE: 1/4" = 1'-0"



PROJECT DESCRIPTION:

INDIANA STATE UNIVERSITY  
THEATER BUILDING DRESSING ROOM / REST ROOM REMODEL


536 N 7th St.,  
Terre Haute, IN 47809

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| DRAWN BY: | TJG              | DESIGNED BY: | TJG   |
| SCALE:    | REFER TO DRAWING | CHECKED BY:  | MJE   |
| DATE:     | 01/21/2025       | JOB NO.:     | 24116 |

SHEET DESCRIPTION:  
FLOOR PLAN - FIRE PROTECTION

SHEET NUMBER:

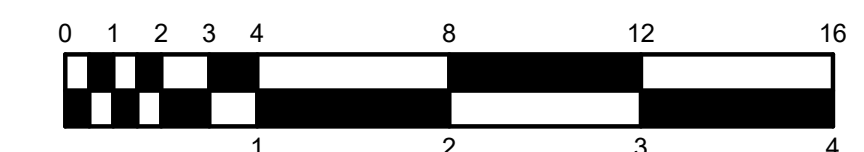FP201



**REVISIONS:**

| NO. | DESCRIPTION | DATE |
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**INDIANA STATE UNIVERSITY  
THEATER BUILDING DRESSING ROOM / REST ROOM REMODEL**

536 N 7th St.,  
Terre Haute, IN 47809

PROJECT DESCRIPTION:

|           |                  |              |       |
|-----------|------------------|--------------|-------|
| DRAWN BY: | EJV              | DESIGNED BY: | EJV   |
| SCALE:    | REFER TO DRAWING | CHECKED BY:  | MJE   |
| DATE:     | 01/21/2025       | JOB NO.:     | 24116 |



SHEET DESCRIPTION:

**FLOOR PLAN -  
MECHANICAL  
DEMOLITION**

SHEET NUMBER:

**MD201**

**DEMOLITION LEGEND:**

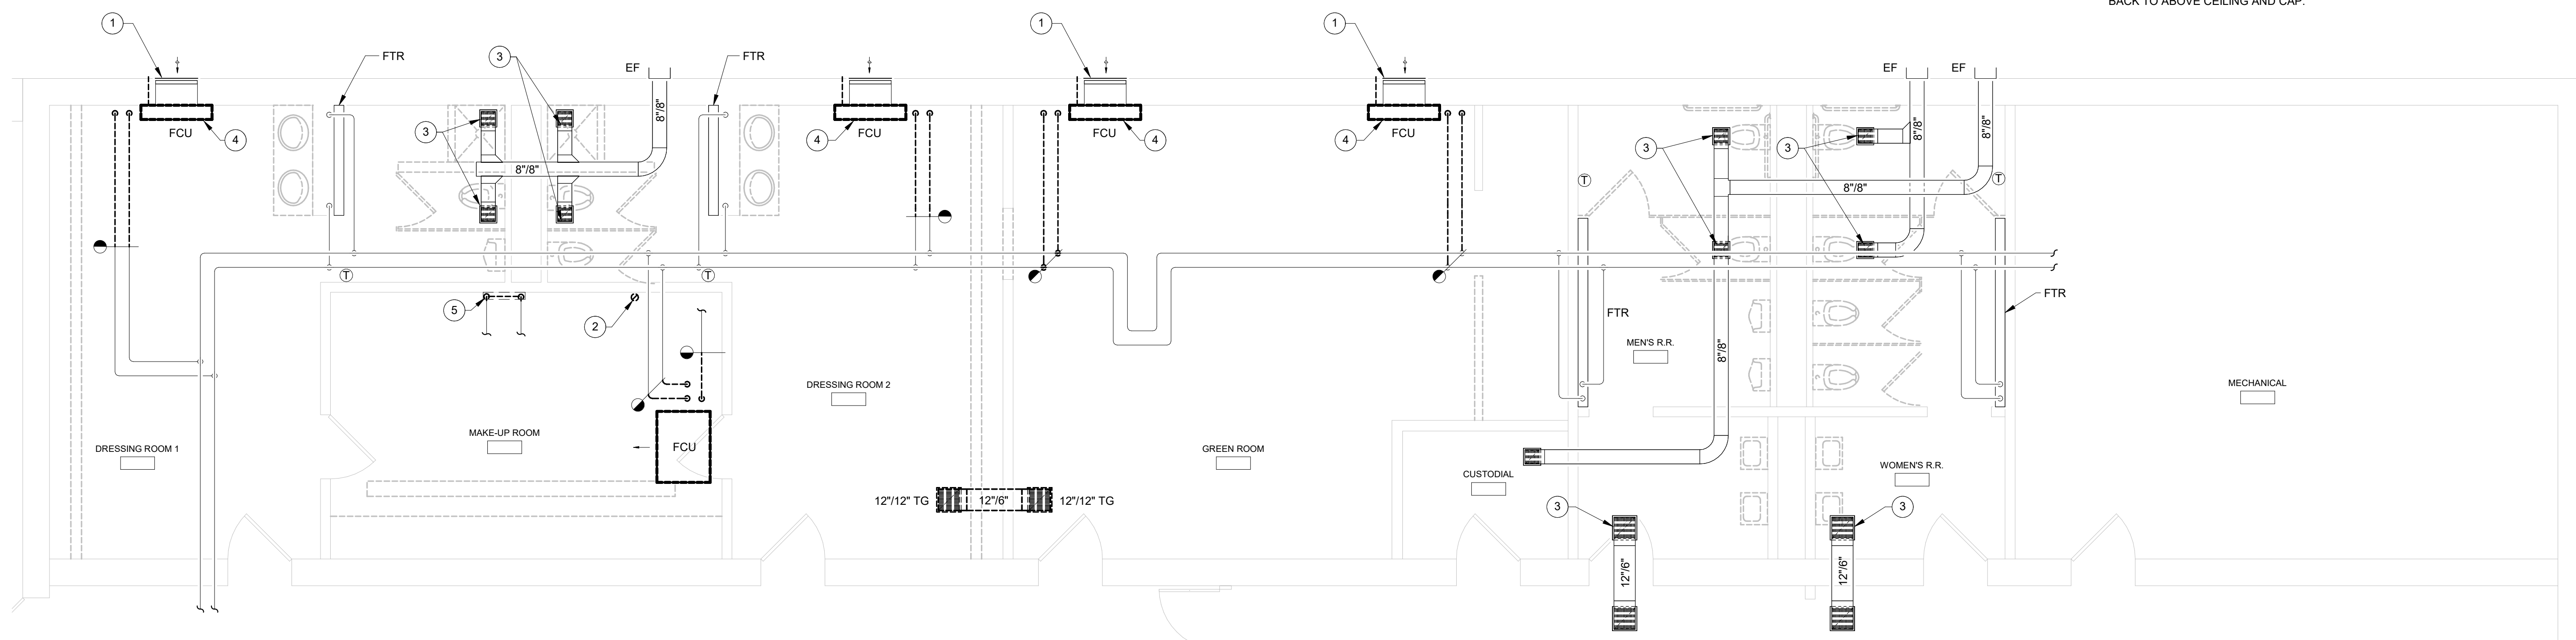
-  WORK TO BE REMOVED
-  WORK TO REMAIN

**GENERAL NOTES - DEMOLITION:**


- THESE NOTES APPLY TO ALL PLUMBING AND MECHANICAL DEMOLITION DRAWINGS.
- REMOVE ALL PIPING, EQUIPMENT, VALVES, ETC., DRAWN DARK DASHED AND LABELED. ALL PIPING, EQUIPMENT, VALVES, ETC., DRAWING LIGHT SHALL REMAIN.
- ALL PIPING, DUCTWORK AND EQUIPMENT ABANDONED BY NATURE OF NEW CONSTRUCTION SHALL BE REMOVED IN THIS CONTRACT.
- THOROUGHLY REVIEW ALL DRAWINGS PRIOR TO ANY DEMOLITION WORK. ANY DEVICES REMOVED ACCIDENTALLY WILL BE REPLACED AT NO ADDITIONAL COST TO OWNER.
- INSTALL CAPS ON ALL PIPING AND DUCTWORK WHERE THEY ARE LEFT OPEN ENDED BY DEMOLITION. PROVIDE TAGS FOR ALL ABANDONED OR CAPPED PIPING LISTING OLD SERVICE.
- DISPOSAL OF DEMOLISHED MATERIALS SHALL COMPLY WITH ALL LOCAL, STATE AND FEDERAL REGULATIONS.
- FIELD VERIFY ALL EXISTING CONDITIONS AS TO EXACT SERVICE, LOCATION, TYPE OF MATERIAL, ETC. BEFORE BIDDING AND BEFORE BEGINNING ANY DEMOLITION.
- REMOVE ALL HANGERS, STRAPS, BRACKETS, PIPE SUPPORTS, ANCHORS, EXPANSION JOINTS, ETC. ASSOCIATED WITH DUCTWORK AND/OR PIPING TO BE REMOVED.
- REPAIR OR REPLACE PIPE AND DUCT INSULATION DAMAGED DURING DEMOLITION OR RENOVATION TO MATCH ORIGINAL CONDITION.
- MECHANICAL CONTRACTOR SHALL PATCH ALL OPENINGS LEFT BY REMOVAL OF MECHANICAL OR PLUMBING PIPE, DUCTWORK, ETC. IN EXISTING WALLS AND FLOORS, UNLESS SPECIFICALLY NOTED TO BE PERFORMED BY OTHERS. WORK BY OTHERS INDICATED ON 'A' AND 'S'-SERIES DRAWINGS. REPAIR SURFACES TO MATCH EXISTING SURFACES.
- ALL EXISTING WALLS GO TO DECK.
- CEILING REMOVAL AND REPLACEMENT SHALL BE INCLUDED IN BID IF REQUIRED TO INSTALL PIPES, DUCTWORK OR EQUIPMENT ABOVE EXISTING CEILING.
- OWNER HAS FIRST RIGHT OF REFUSAL FOR ALL DEMOLISHED EQUIPMENT. ITEMS TYPICALLY TURNED OVER TO OWNER IN THE PAST INCLUDE, BUT ARE NOT LIMITED TO, PNEUMATIC CONTROLLERS AND STEAM PRESSURE REDUCING VALVES.
- ADDITIONAL GENERAL DEMOLITION NOTES SPECIFIC TO A PARTICULAR DEMOLITION DRAWING ARE NOTED ON THOSE DRAWINGS.

**# PLAN NOTES:**

- PROVIDE RIGID INSULATION BLANKOFF OF O.A. LOUVER AND SEAL WATER-TIGHT. REMOVE CONDENSATE DRAIN PIPING THRU WALL COMPLETE. INFILL OPENING.
- REMOVE DRYER VENT COMPLETE. PATCH ROOF OPENING.
- REMOVE E.A. GRILLES FOR REPLACEMENT WITH SIMILAR.
- REMOVE FAN COIL UNIT COMPLETE. REMOVE PIPING BACK TO LOCATION SHOWN. PREPARE PIPING FOR CONNECTION TO NEW FAN COIL UNIT.
- REMOVE ABANDONED LPS STEAM PIPING ALONG WALL COMPLETE BACK TO ABOVE CEILING AND CAP.



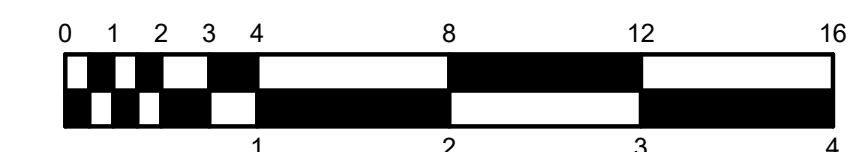**FLOOR PLAN - MECHANICAL DEMOLITION**  
SCALE: 1/4" = 1'-0"  
NORTH



**REVISIONS:**

| NO. | DESCRIPTION | DATE |
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INDIANA STATE UNIVERSITY  
THEATER BUILDING DRESSING ROOM / REST ROOM REMODEL

536 N 7th St.,  
Terre Haute, IN 47809

PROJECT DESCRIPTION:

|           |                  |              |       |
|-----------|------------------|--------------|-------|
| DRAWN BY: | EJV              | DESIGNED BY: | EJV   |
| SCALE:    | REFER TO DRAWING | CHECKED BY:  | MJE   |
| DATE:     | 01/21/2025       | JOB NO.:     | 24116 |

SHEET DESCRIPTION:  
**FLOOR PLAN - MECHANICAL**

SHEET NUMBER:  
**M201**

**RENOVATION LEGEND:**

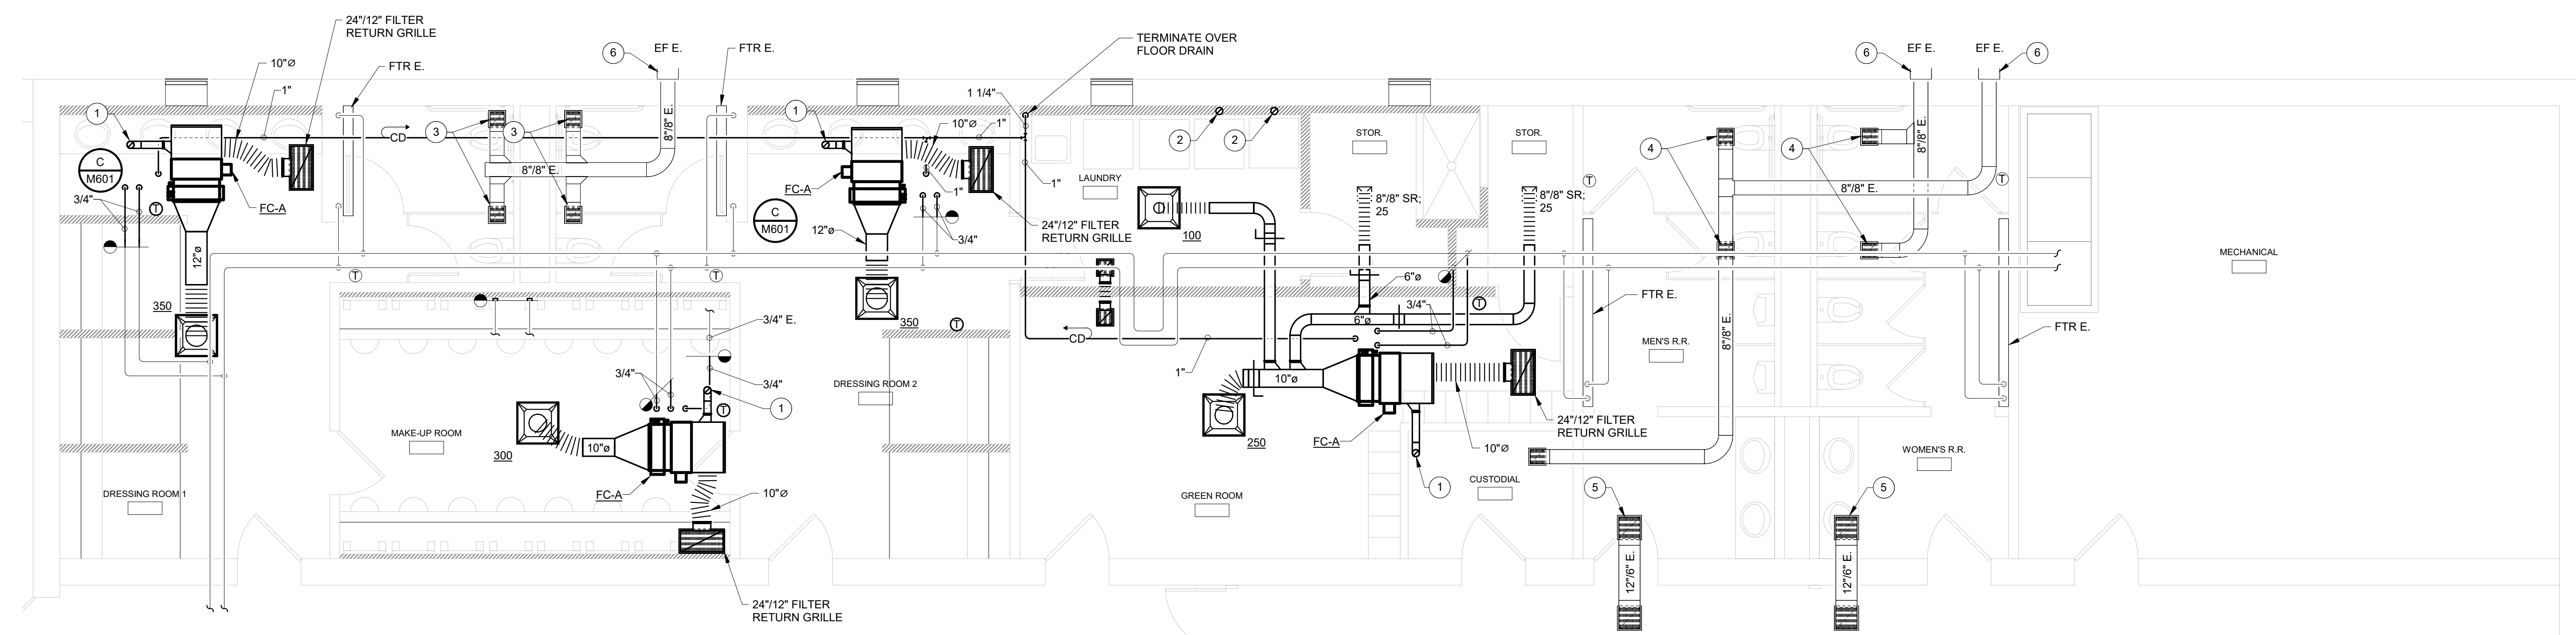
- WORK TO BE INSTALLED
- WORK TO REMAIN

**GENERAL NOTES - AIR DISTRIBUTION:**


1. FLEX DUCT CONNECTIONS TO DIFFUSERS SHALL BE A MAXIMUM OF 3'-0" IN LENGTH.
2. BRANCH DUCTS SHALL HAVE 45° BOOT TAP FROM SIDE OF MAIN. NO SPIN-IN FITTING ALLOWED. SEE DETAIL 'B' / M601.
3. PROVIDE VOLUME DAMPERS IN ALL BRANCH DUCTS TO DIFFUSERS, EXHAUST GRILLES, ETC. WHETHER SHOWN OR NOT. THESE DAMPERS ARE TO BE USED FOR SYSTEM BALANCE. DAMPERS IN DIFFUSERS, REGISTERS, ETC. SHALL NOT BE USED FOR AIR BALANCE.
4. ALL VOLUME DAMPERS SHALL BE LOCATED ABOVE ACCESSIBLE CEILINGS, IF POSSIBLE.
5. COORDINATE AND ADJUST DIFFUSER LOCATIONS, AS NEEDED.
6. SEE DRAWING M601 FOR CEILING DIFFUSER/EXHAUST AND RETURN REGISTER SCHEDULE.
7. ALL TRANSFER OPENINGS TO BE ABOVE CEILINGS.
8. SUPPLY DIFFUSERS TO BE INSTALLED NO CLOSER THAN 4'-0" TO ALL SMOKE DETECTORS. REFER TO T-SERIES AND E-SERIES DRAWINGS FOR ADDITIONAL CEILING INSTALLED DEVICES. COORDINATE AND ADJUST DIFFUSER LOCATIONS, AS NEEDED.
9. EXTERNALLY INSULATE ALL SUPPLY DUCTWORK CONCEALED ABOVE CEILINGS WITH FLEXIBLE FIBERGLASS.
10. THESE ARE NOT FABRICATION DRAWINGS. THESE DRAWINGS ARE NOT INTENDED TO SHOW ALL OFFSETS AS REQUIRED FOR PROPER DUCTWORK INSTALLATION. CONTRACTOR TO FIELD VERIFY ALL EXISTING CONDITIONS AND PREPARE FABRICATION DRAWINGS BASED ON EXISTING CONDITIONS. ALL ADDITIONAL OFFSETS SHALL BE INCLUDED IN BID PRICE.
11. VERIFY FIT OF DUCTWORK PRIOR TO ANY FABRICATION. CONTRACTOR WILL NOT BE REIMBURSED FOR DUCTWORK THAT WILL NOT FIT.
12. REFERENCE M600 SERIES DRAWINGS FOR TYPICAL AND SPECIFIC INSTALLATION REQUIREMENTS FOR EQUIPMENT, ETC.
13. WORKMANSHIP FOR ALL DUCTWORK AND EQUIPMENT MUST BE IN COMPLIANCE WITH SMACNA STANDARDS.
14. INSTALL DUCTS ACCORDING TO SMACNA'S "HVAC DUCT CONSTRUCTION - METAL AND FLEXIBLE" UNLESS OTHERWISE INDICATED.
15. SEAL DUCT SEAMS AND JOINTS FOR DUCT STATIC PRESSURE AND LEAKAGE CLASSES SPECIFIED IN "PERFORMANCE REQUIREMENTS" ARTICLE, ACCORDING TO SMACNA'S "HVAC DUCT CONSTRUCTION STANDARDS - METAL AND FLEXIBLE", TABLE 1-1, "STANDARD DUCT SEALING REQUIREMENTS", UNLESS OTHERWISE INDICATED.
16. EQUIPMENT, VALVES, CONTROLLERS, ETC., REQUIRING SERVICE ABOVE CEILINGS SHALL BE INSTALLED NO HIGHER THAN 18" ABOVE CEILING UNLESS APPROVED BY ENGINEER.
17. ALSO SEE SHEET PM001 FOR ADDITIONAL GENERAL NOTES.

**GENERAL NOTES - CONTROLS:**

1. ALL WORK TO BE COMPLETED BY THE JOHNSON CONTROLS LOCAL BRANCH OFFICE.
2. PROVIDE DDC CONTROL OF ALL FAN COIL UNITS AND INTEGRATE INTO THE OWNER'S B.A.S.
3. ALL WIRING AND COMPONENTS SHALL BE IN COMPLIANCE WITH ISU CAMPUS STANDARDS.



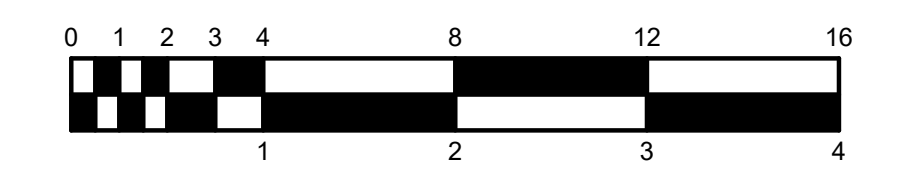**FLOOR PLAN - MECHANICAL**  
SCALE: 1/4" = 1'-0"  
NORTH



CERTIFIED BY:

**REVISIONS:**

| NO. | DESCRIPTION | DATE |
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PROJECT DESCRIPTION:

**INDIANA STATE UNIVERSITY  
THEATER BUILDING DRESSING ROOM / REST ROOM REMODEL**

536 N 7th St.,  
Terre Haute, IN 47809

|           |                  |              |       |
|-----------|------------------|--------------|-------|
| DRAWN BY: | EJV              | DESIGNED BY: | EJV   |
| SCALE:    | REFER TO DRAWING | CHECKED BY:  | MJE   |
| DATE:     | 01/21/2025       | JOB NO.:     | 24116 |

**SCHEDULES & DETAILS - MECHANICAL**

SHEET NUMBER:

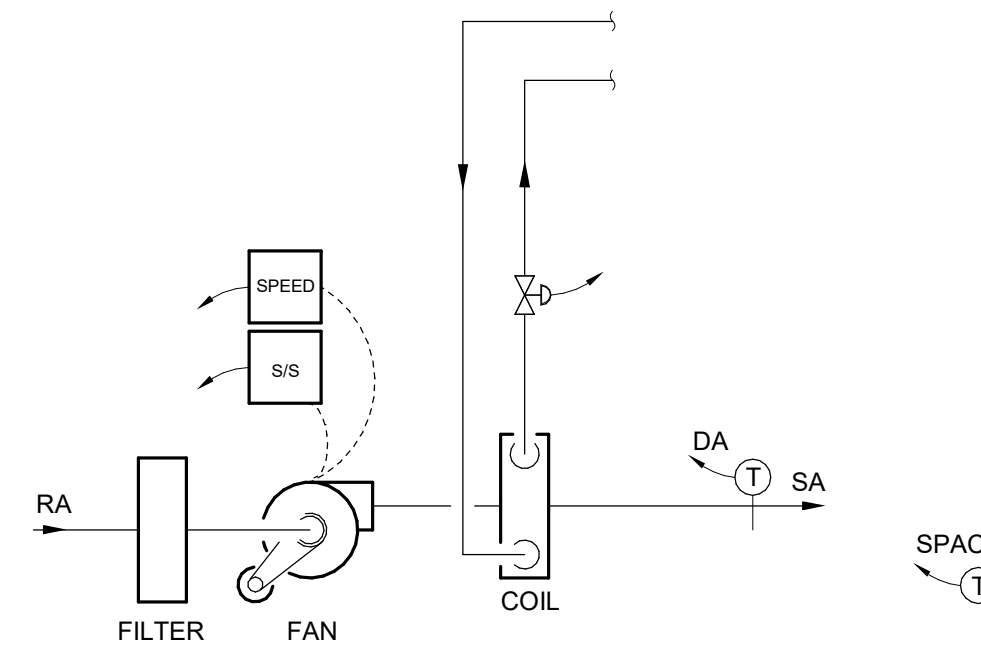
**M601**

**FAN COIL SCHEDULE**

| MARK NO | DRAWING NAME &/OR PURPOSE | SPECIFICATION |               |                        |                         | FAN |     |     |       |      |         | COOLING COIL |      |      |      |               |      | HEATING COIL     |          |              |         |     |     | REMARKS |               |     |                  |          |                                                                   |
|---------|---------------------------|---------------|---------------|------------------------|-------------------------|-----|-----|-----|-------|------|---------|--------------|------|------|------|---------------|------|------------------|----------|--------------|---------|-----|-----|---------|---------------|-----|------------------|----------|-------------------------------------------------------------------|
|         |                           | SECTION       | NAME          | EQUIPMENT TYPE         | MANUFACTURER & MODEL NO | CFM | ESP | FLA | VOLTS | BHP  | MIN MBH | EAT          |      | LAT  |      | CHILLED WATER |      | WATER FLOW (GPM) | MIN ROWS | MAX WPD (FT) | MIN MBH | EAT | LAT |         | HEATING WATER |     | WATER FLOW (GPM) | MIN ROWS | MAX WPD (FT)                                                      |
|         |                           |               |               |                        |                         |     |     |     |       |      |         | DB           | WB   | DB   | WB   | EWT           | LWT  |                  |          |              |         |     |     |         | EWT           | LWT |                  |          |                                                                   |
| FC-A    | M201 HEATING AND COOLING  | 23 82 19      | FAN COIL UNIT | FAN COILS - HORIZONTAL | INTERNATIONAL CPY-04    | 400 | 0.3 | 2.1 | 115   | 0.17 | 11.2    | 75.0         | 63.0 | 55.4 | 53.9 | 45.0          | 55.0 | 2.22             | 4        | 17.0         | 38.0    | 68  | -   | 180     | 160           | -   | 4                | -        | 2-PIPE HEATING AND COOLING. MANUAL CHANGEOVER SYSTEM. DISCONNECT. |


**TYPICAL FCU CONTROL SEQUENCE**

- A. OCCUPIED**
- GLOBAL COMMAND TO INDEX FCU FANS ON AND RUN CONTINUOUSLY.
  - ON A CALL FOR COOLING FROM SPACE MOUNTED DDC TEMPERATURE SENSOR, MODULATE TEMPERATURE CONTROL VALVE OPEN.
  - ON A CALL FOR HEATING FROM SPACE MOUNTED DDC TEMPERATURE SENSOR, MODULATE TEMPERATURE CONTROL VALVE OPEN.
  - WHEN SPACE IS AT SETPOINT MODULATE TEMPERATURE CONTROL VALVE.
  - DDC SPACE THERMOSTAT SHALL ALLOW FOR SPACE SET POINT BETWEEN 70F AND 75F (ADJ)
  - HUMIDITY SENSORS SHOWN ON DRAWINGS ARE FOR REFERENCE ONLY.
  - UPON RECEIVING UNOCCUPIED SIGNAL, INDEX FAN COIL UNIT INTO UNOCCUPIED MODE.
- B. UNOCCUPIED**
- GLOBAL COMMAND TO INDEX FCU FANS OFF AND CYCLE FANS TO MAINTAIN SETBACK SPACE TEMPERATURE.
  - ON A CALL FOR COOLING FROM SPACE MOUNTED DDC TEMPERATURE SENSOR, MODULATE TEMPERATURE CONTROL VALVE OPEN.
  - ON A CALL FOR HEATING FROM SPACE MOUNTED DDC TEMPERATURE SENSOR, MODULATE TEMPERATURE CONTROL VALVE OPEN.
  - WHEN SPACE IS AT SETPOINT CLOSE TEMPERATURE CONTROL VALVE.
  - UNOCCUPIED SPACE SETPOINTS SHALL BE 76F FOR COOLING AND 68F FOR HEATING.
  - MORNING WARM UP CYCLE SHALL COMMENCE AT 6:00 AM.
  - UPON RECEIVING OCCUPANCY SIGNAL, INDEX FAN COIL UNIT INTO OCCUPIED MODE FOR 1 HOUR(ADJ).




**E TYPICAL FC AIRFLOW SCHEMATIC**  
SCALE: NONE


| CONTROL POINTS LIST       |             |    |    |    |
|---------------------------|-------------|----|----|----|
| ITEM                      | SIGNAL TYPE |    |    |    |
| TYPICAL FC                | DI          | AI | AO | DO |
| SPACE TEMPERATURE         |             | 1  |    |    |
| TC VALVE                  |             |    | 1  |    |
| DISCHARGE AIR TEMPERATURE |             | 1  |    |    |
| OCCUPANCY SENSOR          | 1           |    |    |    |
| FAN START/STOP            |             |    |    | 1  |
| FAN SPEED CONTROL         |             |    | 1  |    |
| MISC SPACE HUMIDITY       |             | 1  |    |    |

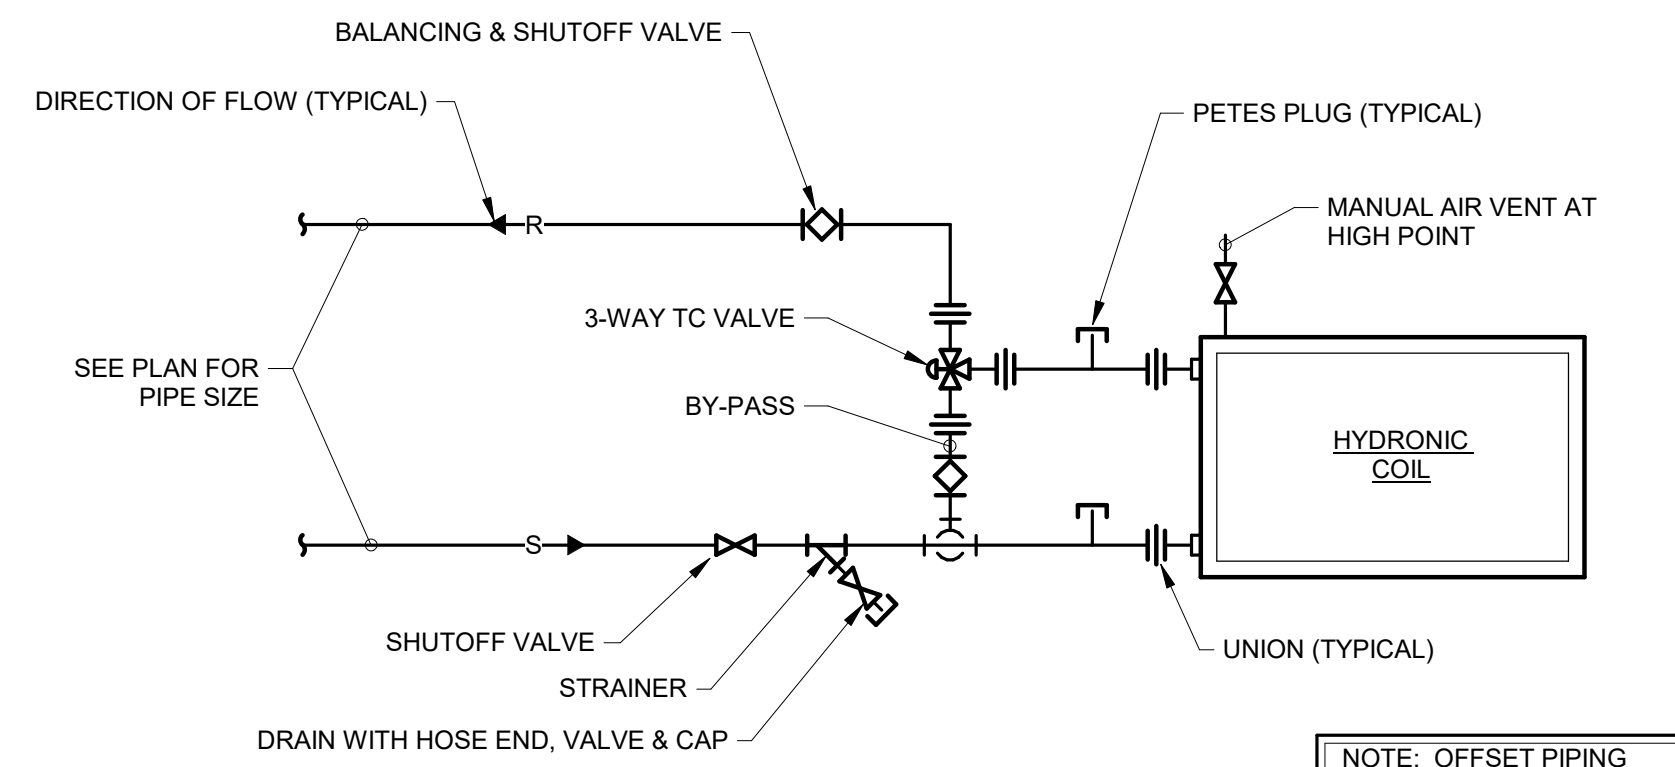

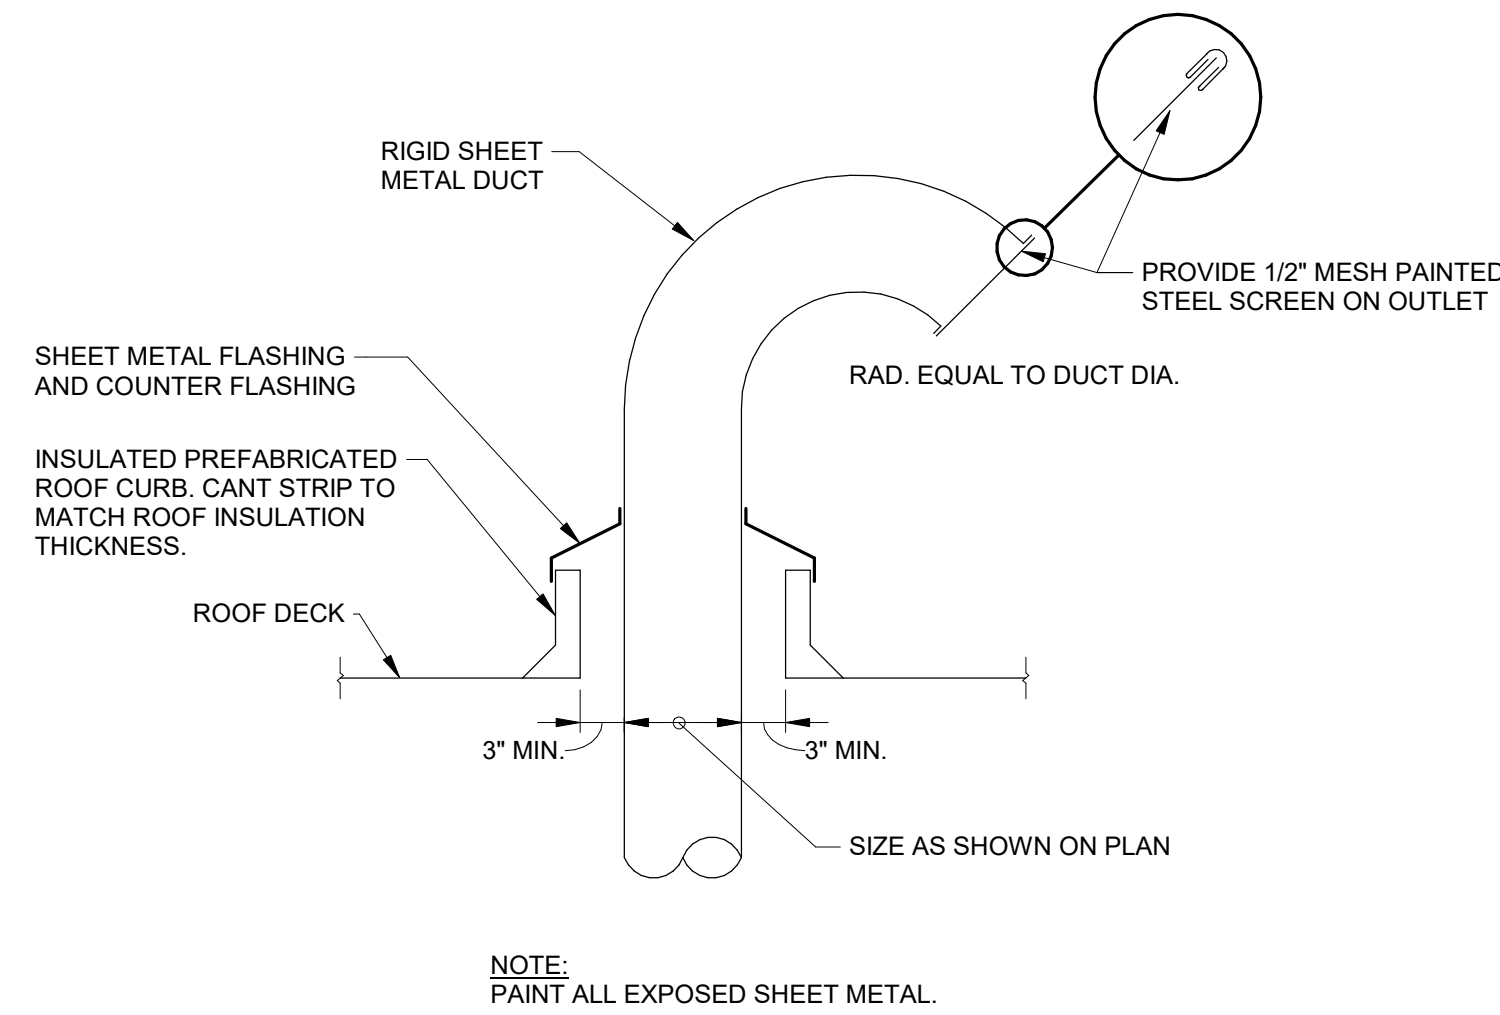**C TERMINAL UNIT HYDRONIC COIL PIPING WITH 3-WAY VALVE**  
SCALE: NONE




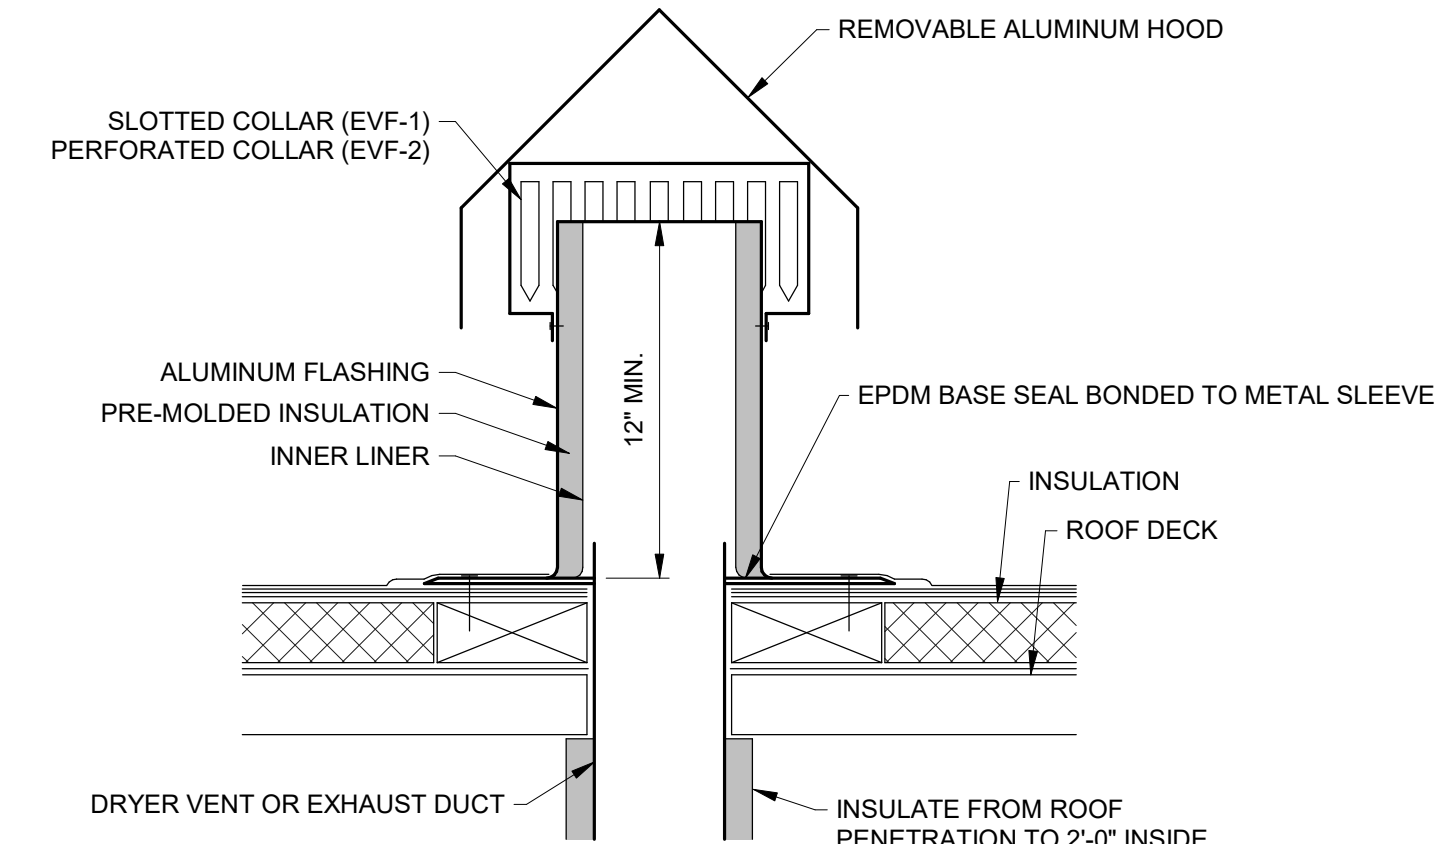**D TYPICAL TERMINATION THRU ROOF**  
SCALE: NONE



- NOTES:**
- PRODUCT TO BE EXHAUST VENT FLASHING (EVF) BY THALER METAL INDUSTRIES.
  - USE THALER EVF-1 (SLOTTED COLLAR) FOR DRYER VENTS ON FLAT ROOFS.
  - USE THALER EVF-2 (PERFORATED COLLAR) FOR EXHAUST VENTS ON FLAT ROOFS.
  - SLIGHT DIFFERENCE IN MODEL. BE SURE TO NOTE SEPARATE MODELS FOR DRYER EXHAUST AND BATHROOM EXHAUST.

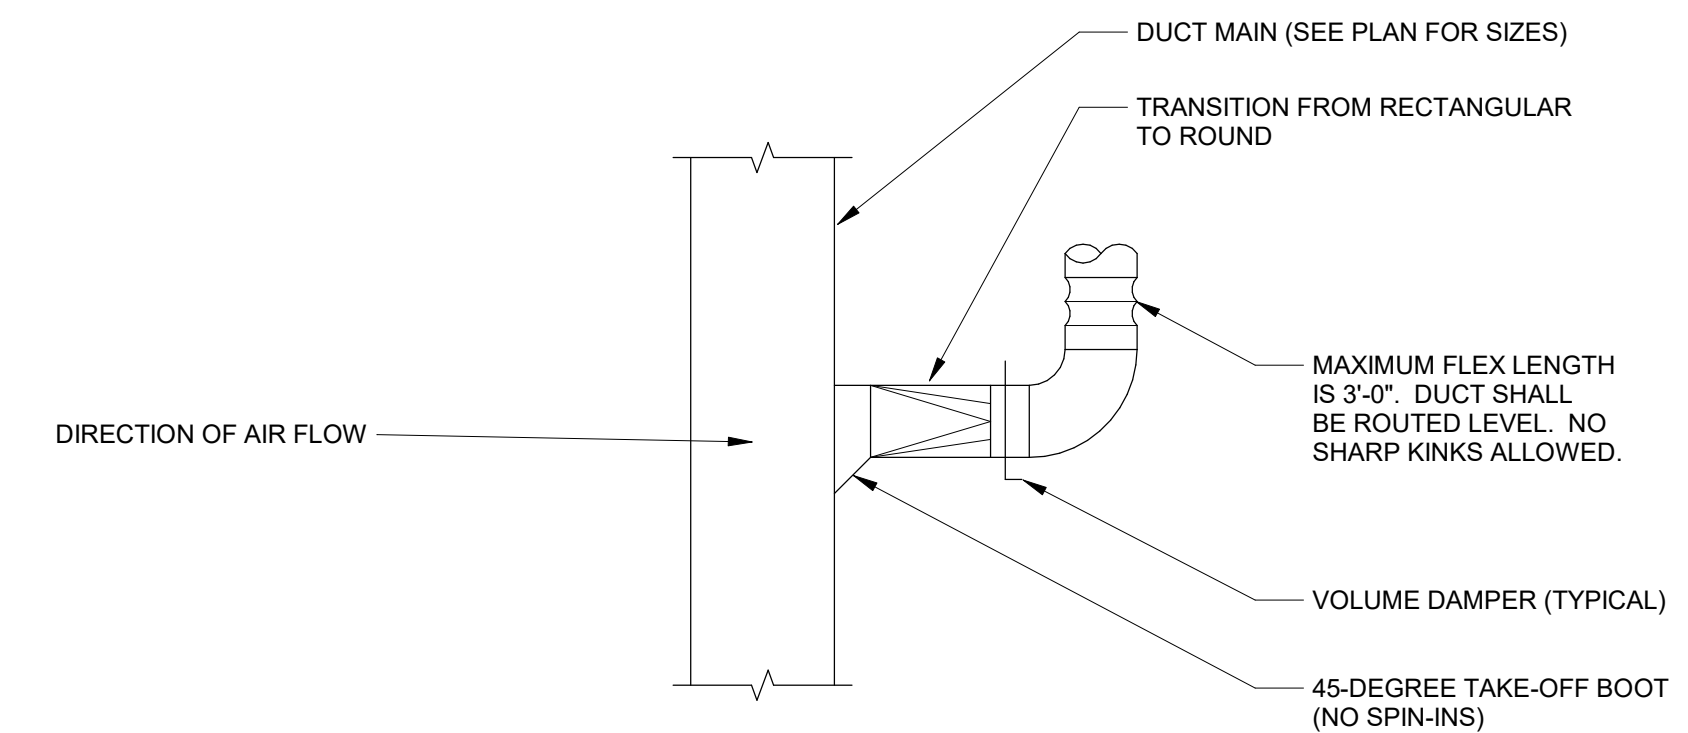
**A TYPICAL DRYER EXHAUST DUCT TERMINATION THRU ROOF**  
SCALE: NONE



**B BRANCH DUCT TAKE-OFF FROM MAIN DUCT**  
SCALE: NONE


**CEILING DIFFUSER SCHEDULE**
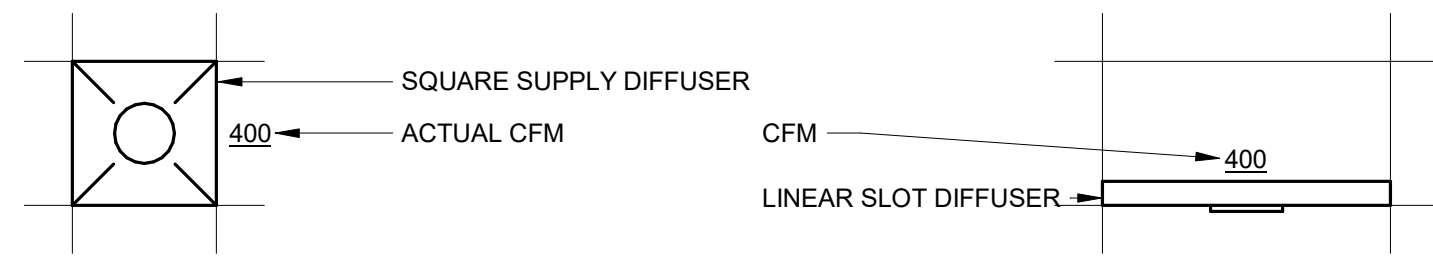
| MARK NO.  | SPECIFICATION NAME      | MANUFACTURER AND MODEL NO. | CFM RANGE | MAX. N.C. | NECK DIA. | FACE SIZE               | CEILING MODULE SIZE |
|-----------|-------------------------|----------------------------|-----------|-----------|-----------|-------------------------|---------------------|
| 50 - 120  | SQUARE CEILING DIFFUSER | PRICE SCDA OR EQUAL        | 50 - 120  | 15        | 6"        | 24/24                   | 24/24               |
| 125 - 245 | SQUARE CEILING DIFFUSER | PRICE SCDA OR EQUAL        | 125 - 245 | 19        | 8"        | 24/24                   | 24/24               |
| 250 - 325 | SQUARE CEILING DIFFUSER | PRICE SCDA OR EQUAL        | 250 - 325 | 19        | 10"       | 24/24                   | 24/24               |
| 330 - 475 | SQUARE CEILING DIFFUSER | PRICE SCDA OR EQUAL        | 330 - 475 | 19        | 12"       | 24/24                   | 24/24               |
| 480 - 645 | SQUARE CEILING DIFFUSER | PRICE SCDA OR EQUAL        | 480 - 645 | 18        | 14"       | 24/24                   | 24/24               |
| 650 - 735 | SQUARE CEILING DIFFUSER | PRICE SCDA OR EQUAL        | 650 - 735 | 18        | 15"       | 24/24                   | 24/24               |
| 130 - 190 | LINEAR SLOT DIFFUSER    | PRICE SDS SERIES OR EQUAL  | 130 - 190 | 18        | 8" OVAL   | (2) 3/4" SLOTS 48" LONG | N/A                 |
| 191 - 230 | LINEAR SLOT DIFFUSER    | PRICE SDS SERIES OR EQUAL  | 191 - 230 | 19        | 8" OVAL   | (2) 1" SLOTS 48" LONG   | N/A                 |
| 231 - 270 | LINEAR SLOT DIFFUSER    | PRICE SDS SERIES OR EQUAL  | 231 - 270 | 18        | 10" OVAL  | (3) 3/4" SLOTS 48" LONG | N/A                 |
| 371 - 340 | LINEAR SLOT DIFFUSER    | PRICE SDS SERIES OR EQUAL  | 271 - 340 | 20        | 10" OVAL  | (3) 1" SLOTS 48" LONG   | N/A                 |
| 341 - 400 | LINEAR SLOT DIFFUSER    | PRICE SDS SERIES OR EQUAL  | 341 - 400 | 21        | 12" OVAL  | (4) 3/4" SLOTS 48" LONG | N/A                 |
| 401 - 520 | LINEAR SLOT DIFFUSER    | PRICE SDS SERIES OR EQUAL  | 401 - 520 | 22        | 12" OVAL  | (4) 1" SLOTS 48" LONG   | N/A                 |



**EXHAUST/RETURN REGISTER SCHEDULE**
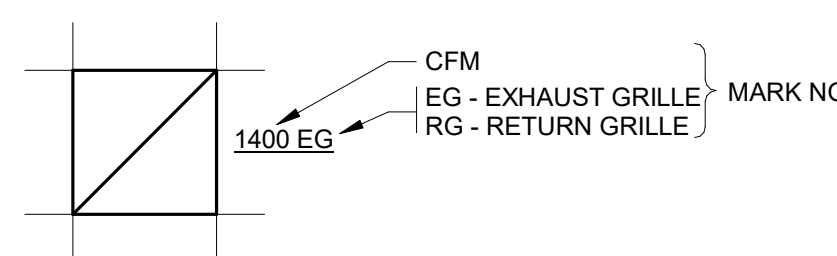
| MARK NO.    | NOMINAL GRILLE SIZE | MAX N.C. | MAX ΔP | CFM RANGE   | REMARKS |
|-------------|---------------------|----------|--------|-------------|---------|
| 0 - 170     | 8/8                 | 20       | 0.1"   | 0 - 170     |         |
| 175 - 240   | 10/10               | 20       | 0.1"   | 175 - 240   |         |
| 245 - 400   | 12/12               | 20       | 0.1"   | 245 - 400   |         |
| 405 - 520   | 14/14               | 20       | 0.1"   | 405 - 520   |         |
| 525 - 640   | 16/16               | 20       | 0.1"   | 525 - 640   |         |
| 645 - 830   | 18/18               | 20       | 0.1"   | 645 - 830   |         |
| 835 - 1050  | 20/20               | 20       | 0.1"   | 835 - 1050  |         |
| 1055 - 1400 | 24/24               | 20       | 0.1"   | 1055 - 1400 |         |





CERTIFIED BY:

**REVISIONS:**

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**INDIANA STATE UNIVERSITY  
THEATER BUILDING DRESSING ROOM / REST ROOM REMODEL**

536 N 7th St.,  
Terre Haute, IN 47809

PROJECT DESCRIPTION:

|                         |                  |
|-------------------------|------------------|
| DRAWN BY: ---           | DESIGNED BY: --- |
| SCALE: REFER TO DRAWING | CHECKED BY: ---  |
| DATE: 01/21/2025        | JOB NO.: 24116   |



SHEET DESCRIPTION:

**FLOOR PLAN -  
ELECTRICAL  
DEMOLITION**

SHEET NUMBER:

**ED201**

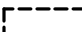**DEMOLITION LEGEND:**


-  WORK TO BE REMOVED
-  WORK TO REMAIN

**GENERAL NOTES:**

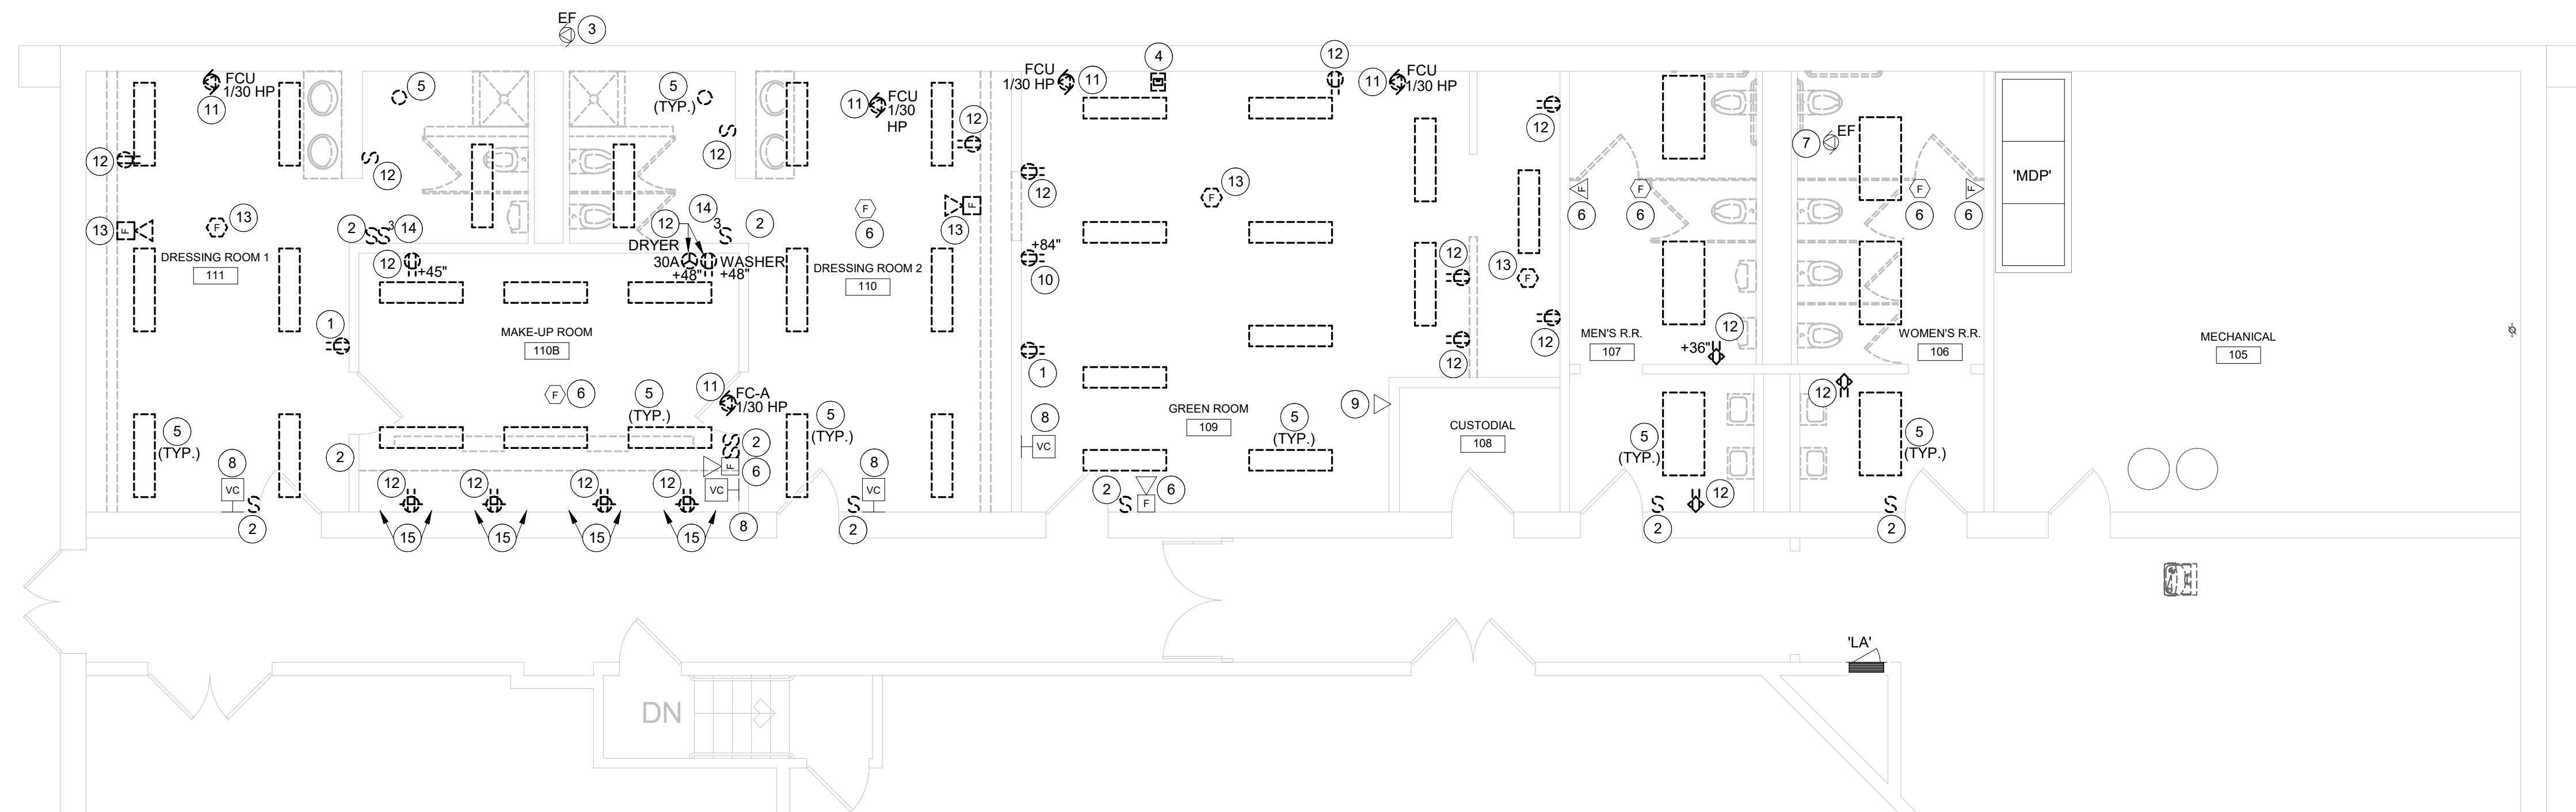
1. SEE E001 FOR GENERAL NOTES.

**PLAN NOTES:**

1. REPLACE RECEPTACLE AND COVERPLATE. SEE E211.
2. REPLACE LIGHT SWITCH AND COVERPLATE. SEE E201.
3. EXHAUST FAN ON WALL TO REMAIN.
4. EXISTING PULL BOX, RELATED CONDUIT AND WIRING TO REMAIN. SEAL EXISTING CONDUIT THROUGH EXTERIOR WALL TO STOP OUTSIDE AIR INFILTRATION.
5. REMOVE LIGHT FIXTURE AND WIRING. TYPICAL.
6. FIRE ALARM DEVICE TO REMAIN. REWORK AS REQUIRED FOR NEW WORK.
7. EXHAUST FAN ON ROOF TO REMAIN.
8. VOLUME CONTROL TO REMAIN. CLEAN AND RELABEL AS DIRECTED.
9. TELECOM JACK TO REMAIN.
10. REMOVE CLOCK RECEPTACLE AND WIRING. PROVIDE BLANK COVERPLATE.
11. REMOVE WIRING AND SURFACE RACEWAY TO FAN COIL UNIT.
12. REMOVE DEVICE AND WIRING IN ITS ENTIRETY. REMOVE ANY ASSOCIATED SURFACE RACEWAY. PROVIDE BLANK COVERPLATE AS NECESSARY.
13. REMOVE FIRE ALARM DEVICE AND SALVAGE FOR REUSE. SEE E211.
14. REPLACE 3-WAY SWITCH WITH PILOT LIGHT TO CONTROL EXHAUST FAN. SEE E211.
15. REMOVE MAKEUP LIGHTING AND ASSOCIATED WIRING AND CONTROLS.



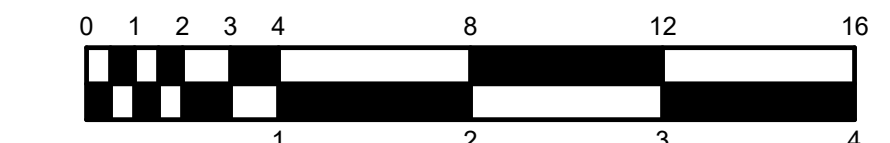**FLOOR PLAN - ELECTRICAL DEMOLITION**  
SCALE: 3/16" = 1'-0"  
NORTH



CERTIFIED BY:

REVISIONS:

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INDIANA STATE UNIVERSITY THEATER BUILDING DRESSING ROOM / REST ROOM REMODEL

536 N 7th St., Terre Haute, IN 47809

PROJECT DESCRIPTION:

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|-------------------------|----------------|
| DRAWN BY:               | DESIGNED BY:   |
| SCALE: REFER TO DRAWING | CHECKED BY:    |
| DATE: 01/21/2025        | JOB NO.: 24116 |

SHEET DESCRIPTION: FLOOR PLAN - LIGHTING

SHEET NUMBER:

E201

| INTERIOR LIGHT FIXTURE SCHEDULE |                                                                                                                                                                                                                                                                                                                                                  |              |       |     |       |        |          |                              |      |  |
|---------------------------------|--------------------------------------------------------------------------------------------------------------------------------------------------------------------------------------------------------------------------------------------------------------------------------------------------------------------------------------------------|--------------|-------|-----|-------|--------|----------|------------------------------|------|--|
| MARK                            | DESCRIPTION                                                                                                                                                                                                                                                                                                                                      | MOUNTING     | WATTS | CR  | COLOR | LUMENS | VOLTS    | MANUFACTURER(S)              | MARK |  |
| F1                              | 2 BY 4-FOOT FLAT PANEL, ACRYLIC LENS, BACK-LIT, 0-10V DIMMING TO 10-PERCENT                                                                                                                                                                                                                                                                      | RECESSED     | 40 W  | 80  | 3500K | 4000   | 120-277V | COLUMBIA CBT24 SERIES        | F1   |  |
| F2                              | SAME AS F1 EXCEPT WILL BE 2 BY 2-FOOT.                                                                                                                                                                                                                                                                                                           | RECESSED     | 38 W  | 80  | 3500K | 4000   | 120-277V | COLUMBIA CBT22 SERIES        | F2   |  |
| F3                              | OPEN DOWNLIGHT, 6-INCH DIAMETER APERTURE, CLEAR SEMI-SPECULAR REFLECTOR, SELF FLANGED, 0-10V DIMMING TO 10-PERCENT, NON-IC RATED                                                                                                                                                                                                                 | RECESSED     | 15 W  | 80  | 3500K | 1100   | 120-277V | PRESCOLITE LBRST-RD SERIES   | F3   |  |
| F4                              | MAKE-UP STATION LIGHTS. SEE ELEVATION ON E201. MED LAMP SOCKETS, 9-INCHES ON CENTER, ROUND WIRE LAMP GUARDS, MITERED CORNERS, EXTRUDED ALUMINUM CHANNEL, METALIC FINISH SELECTED BY ARCHITECT FROM MANUFACTURER'S STANDARD CATALOG OF AVAILABLE FINISHES. COORDINATE LAMP WITH OWNER - LED 'A' LAMP, 3000K, 60W EQUIVALENT AS DIRECTED BY OWNER. | SURFACE WALL | 10 W  | LED | 3000K | -      | 120V     | AIREY-THOMPSON 22X090 SERIES | F4   |  |

RENOVATION LEGEND:

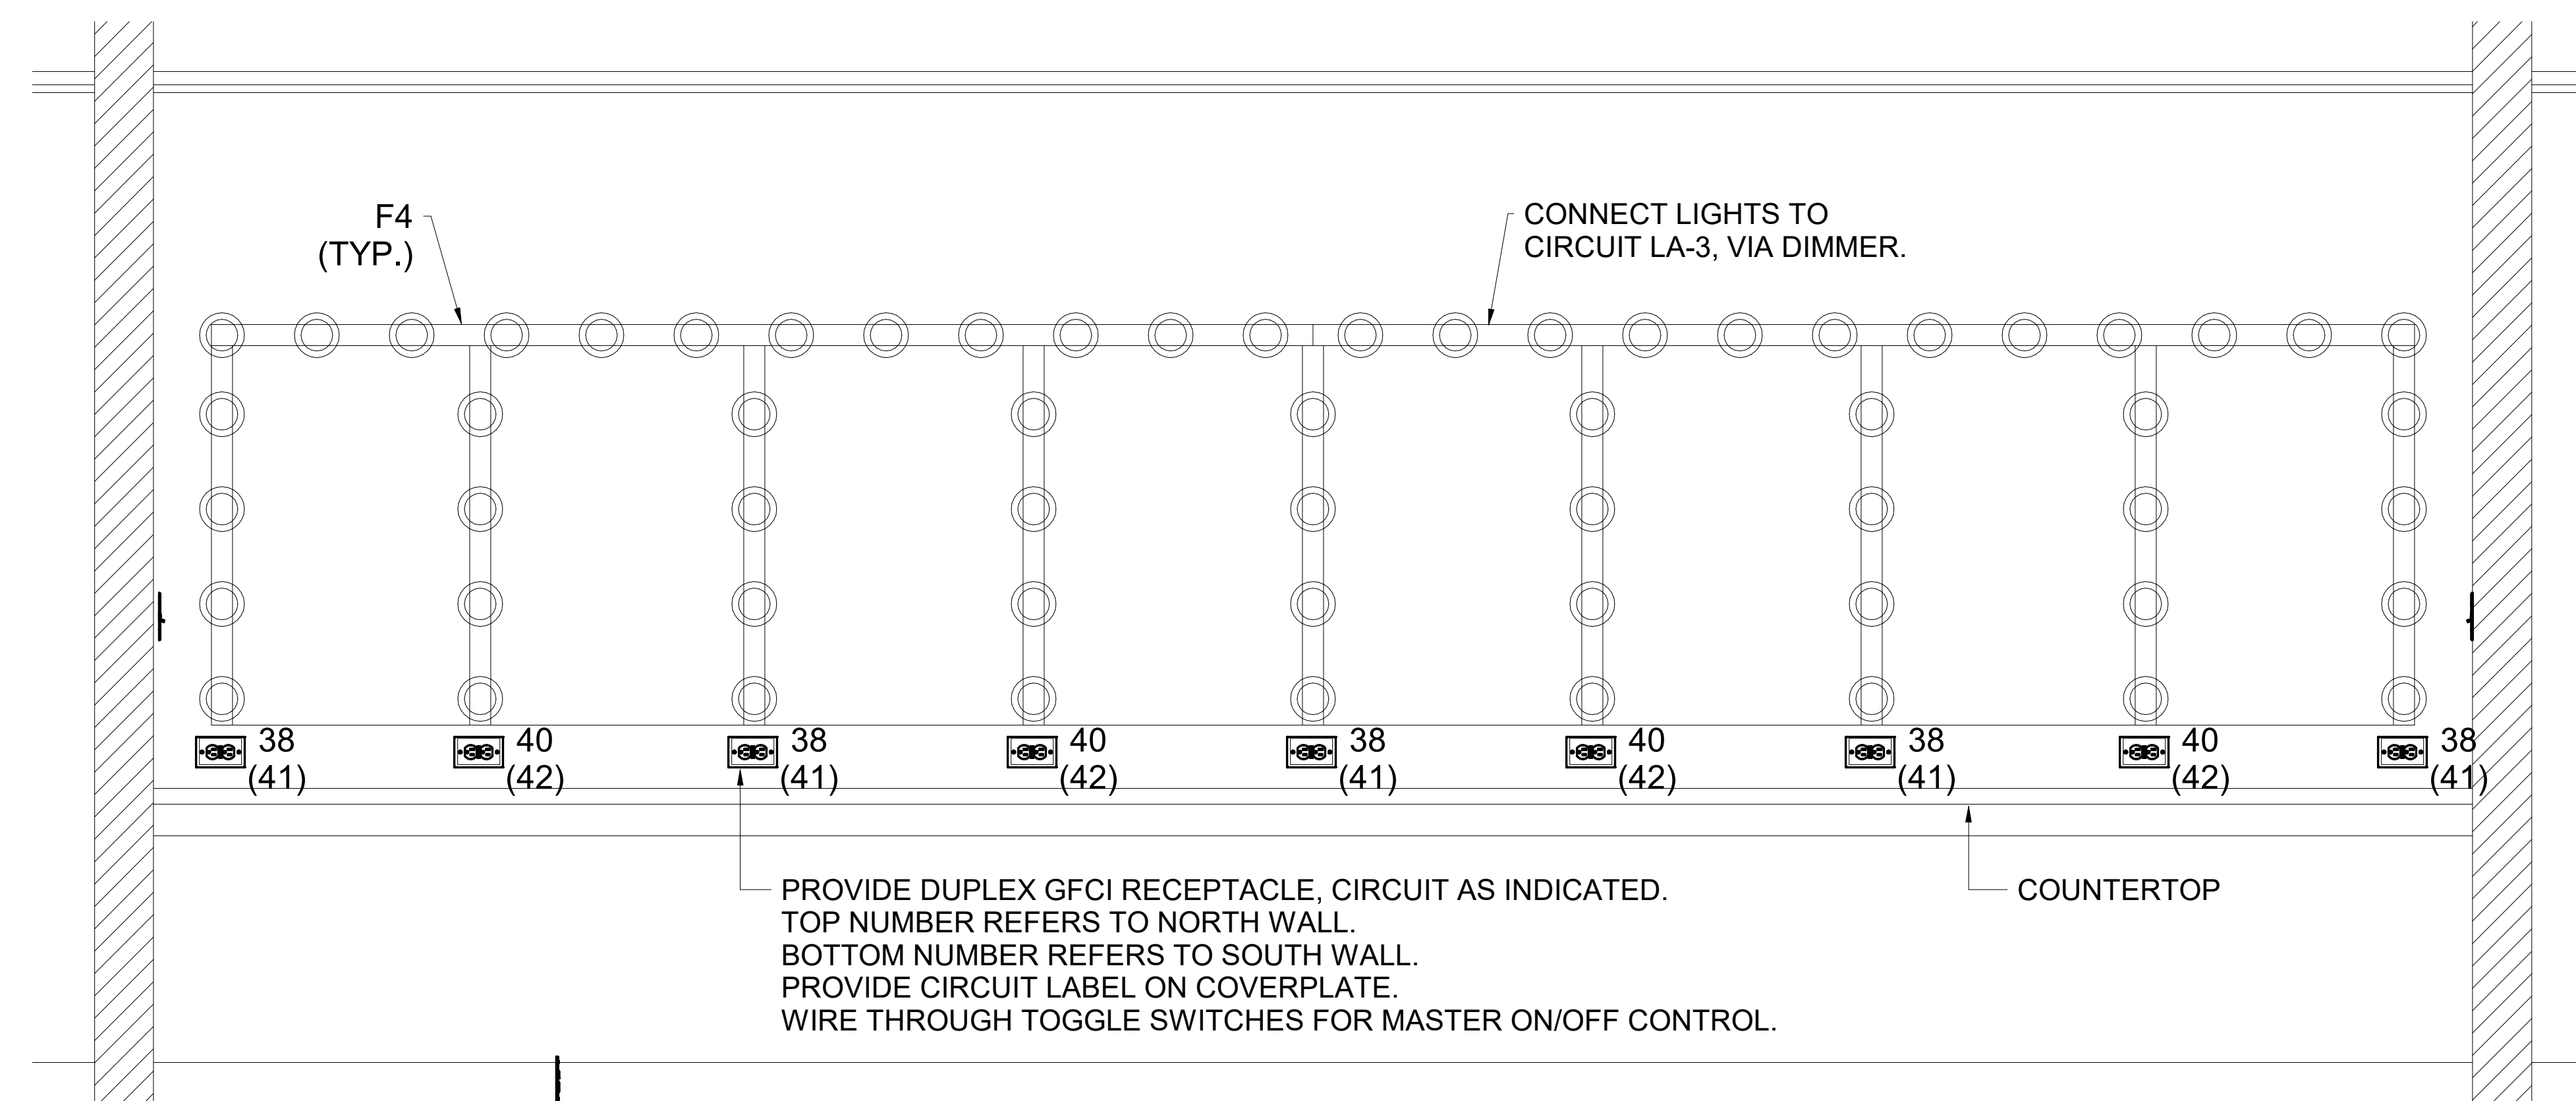
- WORK TO BE INSTALLED
- WORK TO REMAIN

GENERAL NOTES:


- SEE E001 FOR GENERAL NOTES.

PLAN NOTES:


- INSTALL NEW DEVICE IN EXISTING DEVICE BOX. REPLACE WIRING.
- PROVIDE DIMMER SWITCH TO CONTROL MAKEUP LIGHTS.
- PROVIDE MAKEUP STATION LIGHTING. SEE ELEVATION. CIRCUIT TO LA-3



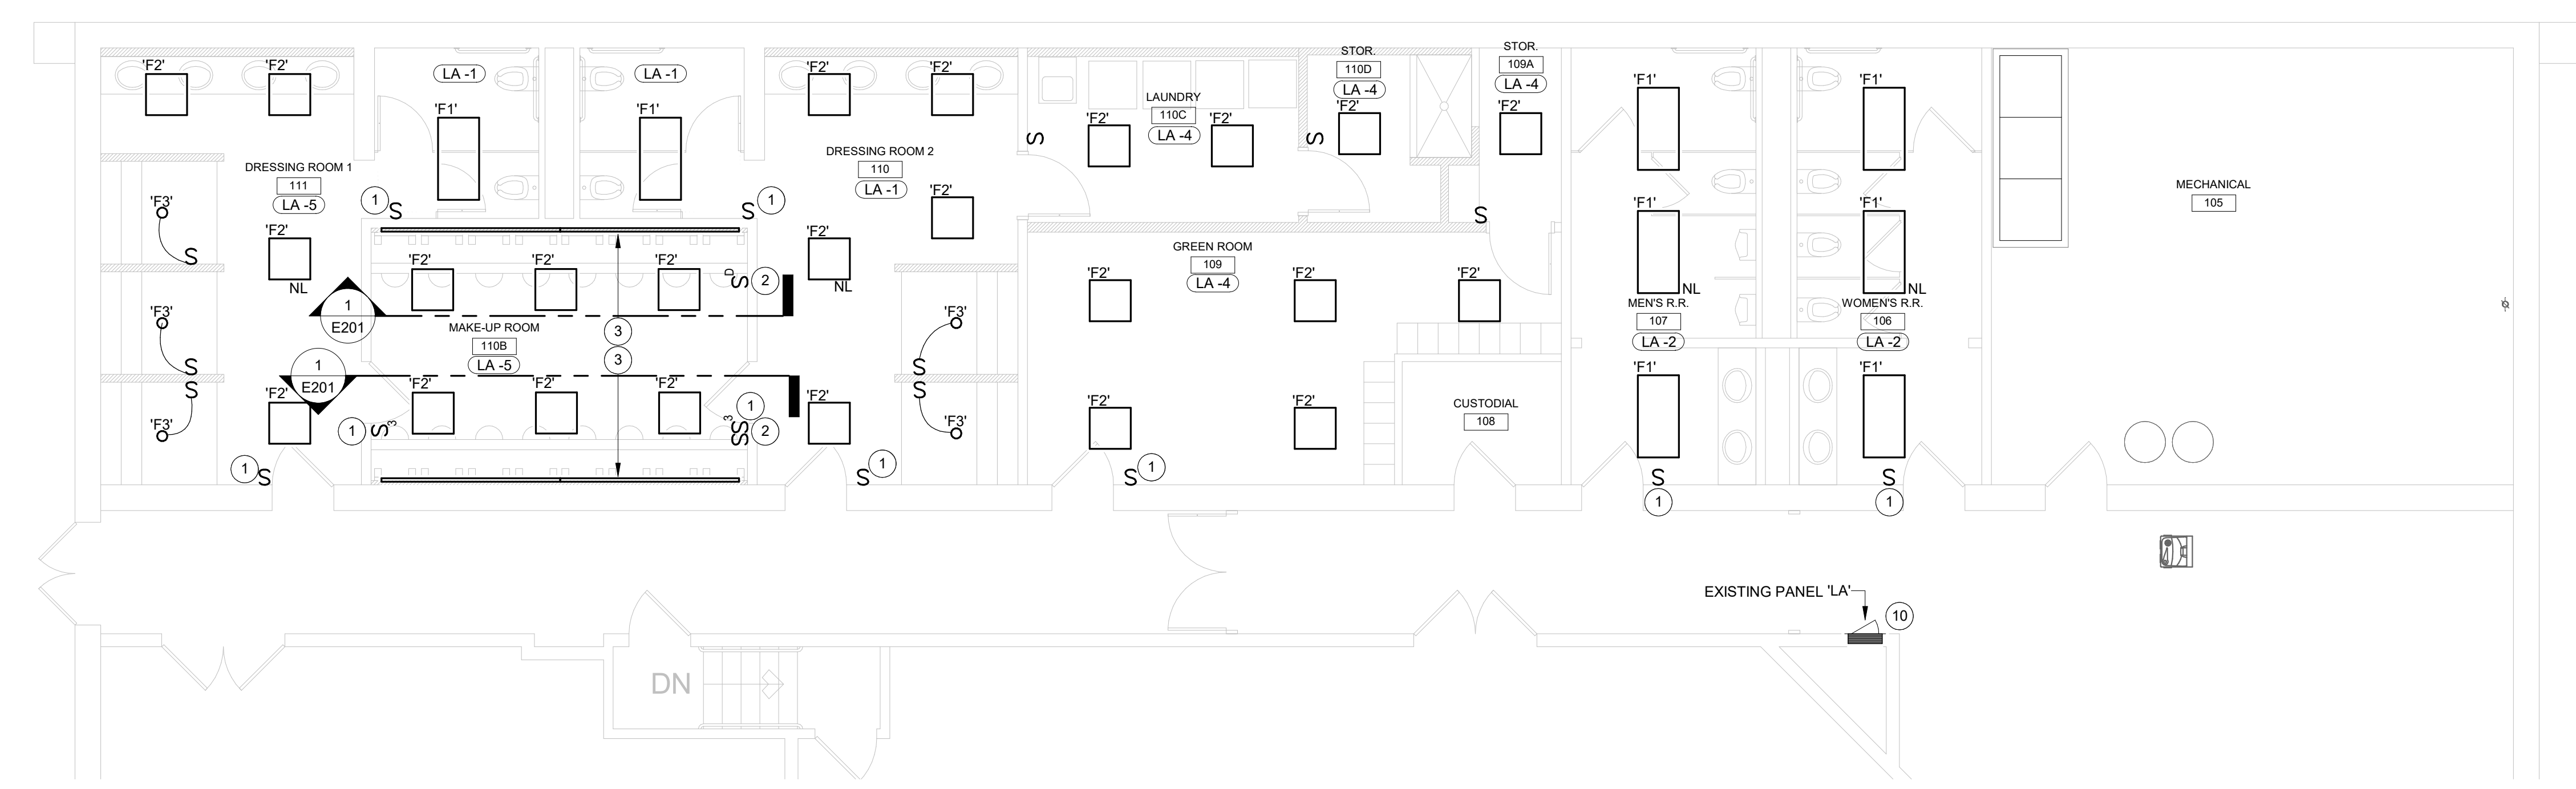1 Makeup Station Elevation (Typical for both North and South wall - Room 110B)



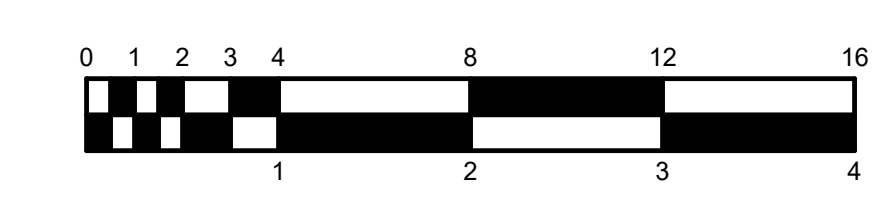FLOOR PLAN - LIGHTING SCALE: 3/16" = 1'-0"



CERTIFIED BY:

**REVISIONS:**

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**INDIANA STATE UNIVERSITY  
THEATER BUILDING DRESSING ROOM / REST ROOM REMODEL**

536 N 7th St.,  
Terre Haute, IN 47809

PROJECT DESCRIPTION:



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| DRAWN BY: ---           | DESIGNED BY: --- |
| SCALE: REFER TO DRAWING | CHECKED BY: ---  |
| DATE: 01/21/2025        | JOB NO.: 24116   |

SHEET DESCRIPTION:  
**FLOOR PLAN -  
POWER AND SIGNAL**

SHEET NUMBER:

**E211**

**RENOVATION LEGEND:**

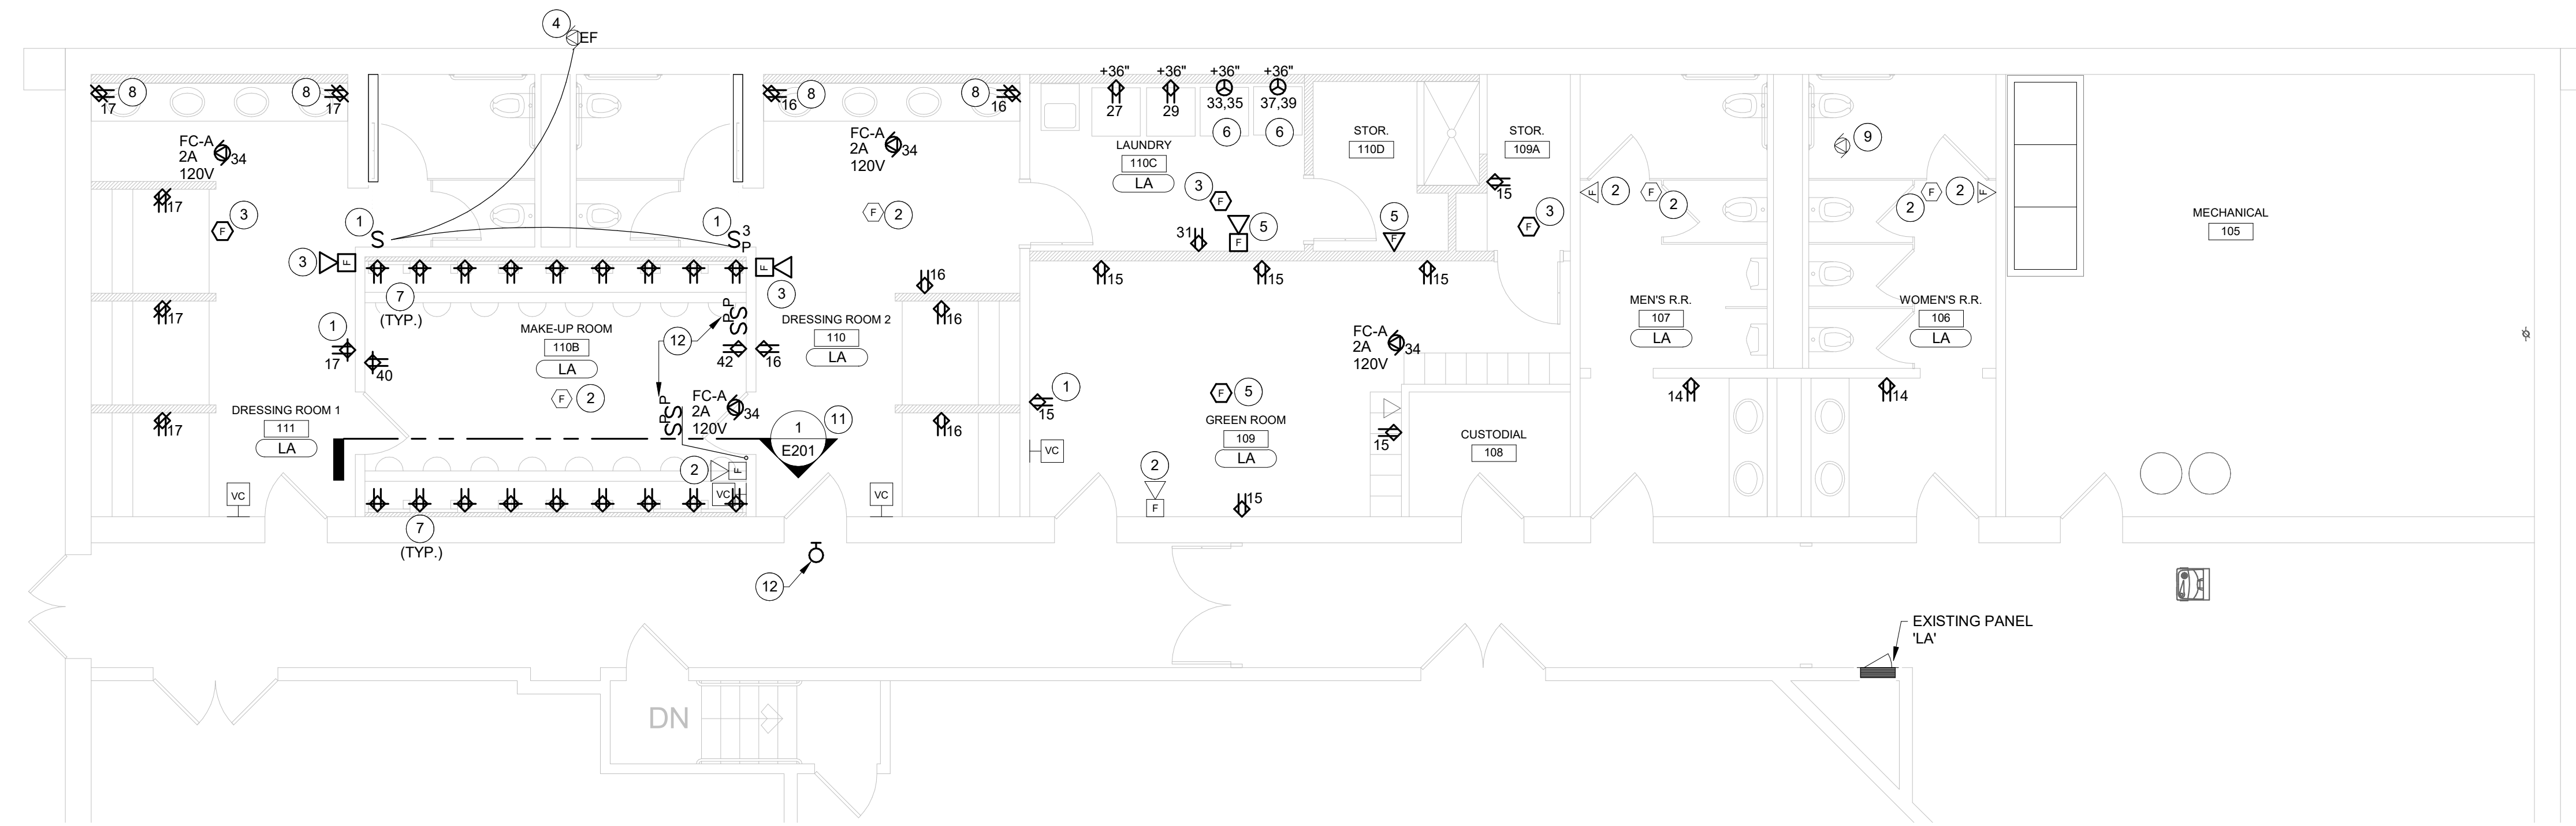
-  WORK TO BE INSTALLED
-  WORK TO REMAIN

**GENERAL NOTES:**

- SEE E001 FOR GENERAL NOTES.
- UPDATE PANEL CIRCUIT DIRECTORY. COORDINATE WITH ENGINEER.
- ALL WIRING SHALL NEW, FROM PANEL TO DEVICE.

**PLAN NOTES:**

- INSTALL NEW DEVICE IN EXISTING DEVICE BOX. REPLACE WIRING.
- EXISTING FIRE ALARM DEVICE TO REMAIN. REWORK AS REQUIRED.
- REINSTALL SALVAGED FIRE ALARM DEVICE. EXTEND WIRING.
- EXISTING EXHAUST FAN TO REMAIN. REWIRE TO NEW SWITCHES AS SHOWN. VERIFY CIRCUIT. REPLACE AS REQUIRED.
- PROVIDE FIRE ALARM DEVICE. MATCH EXISTING. EXTEND EXISTING WIRING.
- PROVIDE A NEMA 14-30R, 30A, 125/250V, 3-POLE, 4-WIRE RECEPTACLE FOR CLOTHES DRYER. WIRE WITH #10 CONDUCTORS.
- PROVIDE DEVICE ABOVE COUNTER. SEE ELEVATION ON E201 FOR LOCATION AND CIRCUITING.
- INSTALL DEVICE ABOVE COUNTER. COORDINATE LOCATION WITH OTHER ACCESSORIES AND OWNER.
- EXISTING ROOF EXHAUST FAN TO REMAIN. REFEED AS REQUIRED. VERIFY CONTROLS.
- PROVIDE (1) 30A-2P CIRCUIT BREAKER IN SPACES 37 AND 38, AND (4) 20A-1P BREAKERS IN SPACES 38, 40, 41, AND 42 IN EXISTING PANEL 'LA'. MATCH EXISTING BREAKERS (SOD NOOB)
- ELEVATION SHOWN IS TYPICAL OF NORTH WALL AND SOUTH WALL.
- PROVIDE TOGGLE SWITCHES WITH PILOT LIGHT TO CONTROL RECEPTACLE CIRCUITS AT MAKEUP COUNTER, WITH PILOT LIGHTS IN CORRIDOR. PILOT LIGHTS TO BE ON WHEN POWER IS ON AT RECEPTACLES. PER NEC 520.73 (2008).



**FLOOR PLAN - POWER AND SIGNAL**  
SCALE: 3/16" = 1'-0"  
NORTH

